# PRELIMINARY DESIGN SUBMITAL 11 & 15 ELM STREET

HARVARD, MA 01451 SUBMISSION DATE: JUNE 15, 2017

PREPARED FOR:

# TOWN OF HARVARD


HILDRETH HOUSE HOUSING OVERLAY DISTRICT


13 AYER ROAD

HARVARD, MA 01451

# INDEX OF DRAWINGS

· · · · · · · · · · · · · · · · · · ·		
SHEET NO.	DWG NO.	DRAWING TITLE
1.	CS0001	COVER SHEET
2.	CS0001	LEGEND, NOTES, AND ABBREVIATIONS
3.	CS0201	EXISTING CONDITIONS PLAN
4.	V0801	ROADWAY LAYOUT AND PROPERTY LINE PLAN
5.	CS1001	LAYOUT AND MATERIALS PLAN
6.	CS1501	GRADING AND DRAINAGE PLAN
7.	CS1701	UTILITY PLAN
8.	CS3501	ROAD PROFILE PLAN
9.	CS6001	SITE DETAILS
10.	CS6021	DRAINAGE DETAILS
11.	CS6051	UTILITY DETAILS
12.	CS8001	<b>EROSION &amp; SEDIMENTATION CONTROL PLAN</b>
13.	CS8501	<b>EROSION &amp; SEDIMENTATION CONTROL NOTES</b>

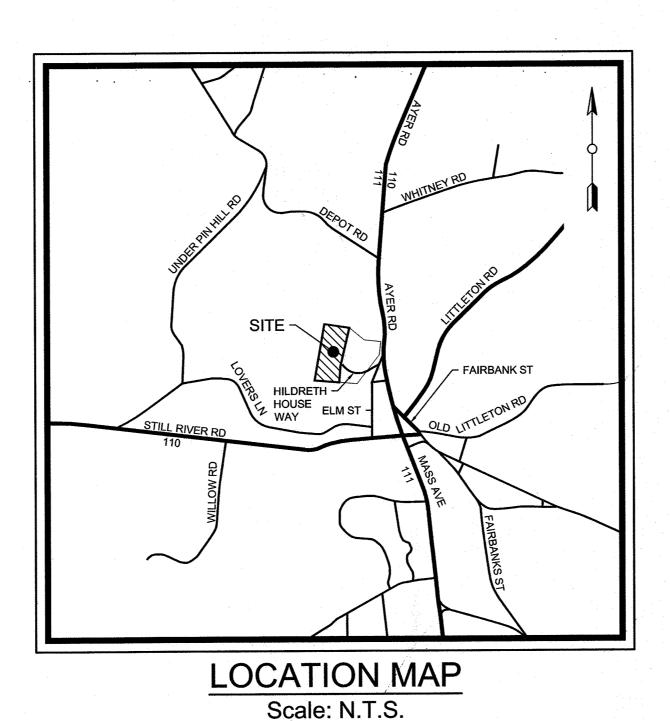

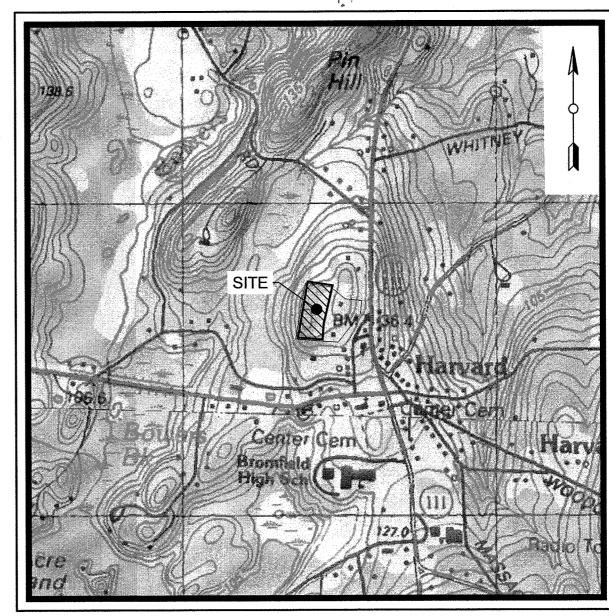

USGS MAP
Scale: N.T.S.



THE LAW REQUIRES NOTIFICATION
BY EXCAVATORS, DESIGNERS, OR ANY PERSON PREPARING TO
DISTURB THE EARTH'S SURFACE ANYWHERE IN THE STATE AT
LEAST 72 HOURS BEFORE BEGINNING CONSTRUCTION.
1-888-DIG-SAFE (1-888-344-7233)
WWW.DIGSAFE.COM

# PREPARED BY: TTI ENVIRONMENTAL, INC. A SERVICE DISABLED VETERAN OWNED SMALL BUSINESS (CVE CERTIFIED)



Engineering Division
13 Branch Street, Suite 111
Methuen, MA 01844
T 978.749.9929
F 978.749.9920

CONSULTING • CONTRACTING • ENGINEERING

ALL DIMENSIONS MUST BE VERFIED BY CONTRACTOR AND OWNER MUST BE NOTIFIED OF ANY	AND OWNER MUST BE NOTIFIED OF ANY DISCREPANCIES BEFORE PROCEEDING WITH WORK  COMPANSION OF ANY DISCREPANCIES BEFORE PROCEEDING WITH WORK  STATES OF ANY  STATES OF ANY  STATES OF ANY  STATES OF ANY  COMPANSION OF ANY  COMPA						
THEFT	11 & 15 EI M STREET	HARVARD, MA 01451	ACCECCODIC MAD 170 I OTC 35 8 36		TOWN OF HARVARD	HILDRETH HOUSE HOUSING OVERLAY DISTRICT 13 AYER ROAD	HARVARD, MA 01451
-							ВУ
						. 5	REVISIONS
							М О
					TTI ENVI		
ARE INSTRUMENTS OF SERVICE IN RESPECT OF THE PROJECT. THEY ARE NOT INTENDED OR REPRESENTED TO BE SUITABLE FOR REUSE BY OWNER OR OTHERS ON THE EXTENSIONS OF THE PROJECT OR ON ANY OTHER PROJECT. ANY REUSE WITHOUT WRITTEN VERIFICATION OR ADAPTATION BY TTI ENVIRONMENTAL FOR THE SPECIFIC PURPOSE INTENDED WILL BE AT OWNERS SOLE RISK AND WITHOUT LIABILITY OR LEGAL EXPOSURE TO TTI ENVIRONMENTAL; AND OWNER SHALL INDEMNIFY AND HOLD HARMLESS TTI ENVIRONMENTAL FROM ALL CLAIMS, DAMAGES, LOSSES AND EXPENSES ARISING OUT OF OR RESULTING THEREFROM.							
DATE 17-004  2017-06-15							
DRAW	/ING SO	CALE			AS	NOTE CF	,-,-,
CSO001							
	SHE			1	OF		

			ABBREVI	ATIONS	GENERAL NOTES:
	<u>LEGEND</u>		ADJ	ADJUST	1. EXISTING CONDITIONS INFORMATION
<u>EXISTING</u>		PROPOSED	APPROX BIT	APPROXIMATE BITUMINOUS	A. <u>UTILITIES:</u> THE LOCATIONS OF EXISTING UNDERGROUND UTILITIES ARE SHOWN IN AN APPROXIMATE WAY ONI INDEPENDENTLY VERIFIED BY THE OWNER OR ITS REPRESENTATIVE.
	DUIL DING		BOS	BOTTOM OF SLOPE	THE CONTRACTOR SHALL DETERMINE THE EXACT LOCATION OF ALL EXISTING UTILITIES BEFORE CO
	BUILDING	munine	СВ	CATCH BASIN	AGREES TO BE FULLY RESPONSIBLE FOR ANY AND ALL DAMAGES WHICH MIGHT BE OCCASIONED BY EXACTLY LOCATE AND PRESERVE ANY AND ALL UNDERGROUND UTILITIES. THE CONTRACTOR IS TO
	PROPERTY LINE		CCB	CAPE COD BERM	1-888-344-7233, 72 HOURS PRIOR TO ANY EXCAVATION PERFORMED ON SITE.
	EXCLUSIVE USE AREA		CLDI	CEMENT LINED DUCTILE IRON	2. MATERIALS  A. CURBING:
	ADJACENT PROPERTY LINE SETBACK LINE		C.L.F.	CHAIN LINK FENCE	ON SITE: ALL CURBING ON SITE SHALL BE CAPE COD BERM (CCB) WITH A 4 INCH VERTICAL REVEAL, UNLESS (
	RIGHT-OF-WAY LINE		CONC	CONCRETE	B. BITUMINOUS CONCRETE PAVEMENT:
	RIGHT-OF-WAY EASEMENT		COND	CONDUIT	ROADWAYS:
	ROADWAY CENTERLINE		DCB	DOUBLE CATCH BASIN	SURFACE COURSE: 1-1/2 INCH BITUMINOUS WEARING COURSE  BINDER COURSE: 2-1/2 INCHES BITUMINOUS BINDER COURSE
	STONE WALL FENCE	xx	DH	DRILL HOLE	GRAVEL BASE COURSE: 6 INCHES SELECT COMPACTED DENSE GRADES CRUSHED STONE FOR SUI GRAVEL BASE COURSE: 6 INCHES SELECT COMPACTED SUBBASE M1.030 TYPE C
EOP	EDGE OF PAVEMENT	EOP	DMH	DRAIN MANHOLE	PARKING AREAS & RESIDENTIAL DRIVEWAYS:
	CAPE COD BERM	CCB	DS	DOWN SPOUT	SURFACE COURSE: 1 INCH BITUMINOUS WEARING COURSE BINDER COURSE: 2 INCHES BITUMINOUS BINDER COURSE
	SIDEWALK		ELEV	ELEVATION	GRAVEL BASE COURSE: 8 INCHES SELECT COMPACTED GRANULAR FILL
	OUTCROP/ROCKS		EOG	EDGE OF GRASS	C. <u>BITUMINOUS CONCRETE SIDEWALK:</u> SURFACE COURSE: 1 INCH BITUMINOUS WEARING COURSE
	GRAVEL/RIP RAP		EQ	EQUAL	BINDER COURSE: 1-1/2 INCHES BITUMINOUS BINDER COURSE  GRAVEL BASE COURSE: 8 INCHES SELECT COMPACTED GRANULAR FILL
	GRAVEL/RIF IVAF		ESHGW	ESTIMATED SEASONAL HIGH GROUND	
	BIT. CONC. PAVEMENT		ESHGW	WATER	D. LANDSCAPE AREAS:  ALL DISTURBED AREAS NOT COVERED BY STRUCTURES OR PAVEMENT AND NOT OTHERWISE SPEC
	BIT. CONC. SIDEWALK		EXIST	EXISTING	SHALL RECEIVE 6 INCHES OF TOPSOIL. THESE AREAS ARE TO BE SEEDED AND WATERED UNTIL A H OBTAINED OR MULCHED AS DIRECTED BY THE ARCHITECT.
			FDN	FOUNDATION	E. DISTURBED AREAS:
	BIT. CONC. DRIVEWAY		FES	FLARED END SECTION	AREAS OUTSIDE THE LIMITS OF PROPOSED WORK DISTURBED BY THE CONTRACTOR'S OPERATION CONTRACTOR TO THEIR ORIGINAL CONDITION AT THE CONTRACTOR'S EXPENSE.
46.34 x	SPOT ELEVATION	46.34 x	FND	FOUND	F. LAYOUT DIMENSIONS:
	LIGHT	<b>\$</b>	FP	FIRE PROTECTION SERVICE	LAYOUT DIMENSIONS ARE FROM FACE OF BUILDINGS, RETAINING WALLS, CURBS OR BERMS.
	SIGN	<del>"</del>	F&G	FRAME AND GRATE	G. TRAFFIC CONTROLS:  ALL SITE SIGNAGE AND PAVEMENT MARKINGS SHALL CONFORM TO THE MANUAL OF UNIFORM TRA
•	TEST PIT LOCATION		F&C	FRAME AND COVER	H. ADA CONFORMANCE:
	PERCOLATION LOCATION		GF	GARAGE FLOOR	ALL HANDICAPPED ACCESSIBLE RAMPS AND SIDEWALKS SHALL BE CONSTRUCTED IN CONFORMAN DISABILITIES ACT AND THE MASSACHUSETTS ARCHITECTURAL ACCESS BOARD (WHICHEVER IS MO
and the second control of the second	CONTOUR		HDPE	HIGH DENSITY POLYETHYLENE PIPE	3. UTILITIES
annuari Melanciari Mel	WATER LINE DOMESTIC	w w	HYD	HYDRANT	A. EXISTING UTILITIES:  THE LOCATION AND ELEVATIONS OF EXISTING UTILITIES AS SHOWN ON THESE PLANS ARE BASED (
management 5 management 5 management 5 management	SANITARY SEWER	s s	INV	INVERT ELEVATION	AND SHALL BE VERIFIED BY THE CONTRACTOR PRIOR TO CONSTRUCTION AND PRIOR TO ORDERING
where $D$ is a superior $D$ i	STORM SEWER	110 110 110	IP ·	IRON PIPE	B. PRIVATE UTILITIES: THE LOCATION, SIZE, DEPTH, AND SPECIFICATIONS FOR CONSTRUCTION OF PROPOSED PRIVATE L
	GAS LINE UNDERGROUND ELECTRIC	E E	IR	IRON ROD	ACCORDANCE WITH THE REQUIREMENTS PROVIDED BY, AND APPROVED BY, THE RESPECTIVE UTIL OR ELECTRIC) FINAL DESIGN AND LOCATIONS AT THE BUILDING WILL BE PROVIDED BY THE ARCHI
annoncommuna Offic annoncommuna Offic onnamonamento Offic annoncommuna Offic annoncommuna anno	OVERHEAD ELECTRIC		L/A	LANDSCAPE AREA	COORDINATE THE INSTALLATION OF THE UTILITY CONNECTIONS WITH THE RESPECTIVE UTILITY CONSTRUCTION OR DEMOLITION.
	SANITARY MANHOLE	<b>S</b>	MAX	MAXIMUM	C. EXTERIOR LIGHTING:
	STORM DRAIN MANHOLE	0	MIN	MINIMUM	ON-SITE LIGHTING SHALL BE LOCATED AS SHOWN ON THE UTILITY AND LIGHTING PLANS AND CONF
	STORM DRAIN INLET		NIC	NOT IN CONTRACT	D. STORM DRAINAGE: STORM DRAIN PIPING SHALL BE HIGH DENSITY POLYETHYLENE PIPE (HDPE) WITH CORRUGATED EX
	STORM DRAIN FLARED END SECTION	<b>.</b>	NTS	NOT TO SCALE	LOCK TIGHT JOINTS UNLESS OTHERWISE NOTED ON THE GRADING & DRAINAGE PLAN.
	CONIFEROUS TREE		ocs	OUTLET CONTROL STRUCTURE	E. PROPOSED STRUCTURES: RIM ELEVATIONS OF PROPOSED DRAINAGE MANHOLES AND ASSOCIATED STRUCTURES ARE APPR
			OE	OVERHEAD ELECTRIC	TO BE SET FLUSH AND CONSISTENT WITH THE GRADING PLAN. ADJUST ALL OTHER RIM ELEVATION GAS GATES AND OTHER UTILITIES TO FINISH GRADE WITHIN LIMITS OF WORK.
	DECIDUOUS TREE		PC	POINT OF CURVATURE	
.~~~~~~~~~~~~~~~~~~~~~~~~~~~~~~~~~~~~~~	TREE LINE		PCC	POINT OF CURVE-CURVE	F. GENERAL CONSTRUCTION REQUIREMENTS:  a. THE CONTRACTOR IS SPECIFICALLY CAUTIONED THAT THE LOCATION AND/OR ELEVATION OF E
<b>-</b> &-	FIRE HYDRANT	<b>&amp;</b>	PERF	PERFORATED	THESE PLANS IS BASED ON RECORDS OF THE VARIOUS UTILITY COMPANIES AND, WHERE POST THE FIELD, THE INFORMATION IS NOT TO BE RELIED ON AS BEING EXACT OR COMPLETE. THE C
	WATER VALVE	<b>#</b>	PRC	POINT OF REVERSE CURVE-CURVE	APPROPRIATE UTILITY COMPANY AT LEAST 72 HOURS BEFORE ANY EXCAVATION TO REQUEST UTILITIES. IT SHALL BE THE RESPONSIBILITY OF THE CONTRACTOR TO RELOCATE ALL EXISTING
Protocol		[0,0,0,0,0]	PROP	PROPOSED	THE PROPOSED IMPROVEMENTS SHOWN ON THE PLANS.
	CONSTRUCTION ENTRANCE			POINT OF TANGENT	<ul> <li>b. ALL NECESSARY INSPECTIONS AND/OR CERTIFICATION REQURED BY CODES AND/OR UTILITY S PERFORMED PRIOR TO ANNOUNCED BUILDING POSSESSION AND THE FINAL CONNECTION OF S</li> </ul>
	SILT SACK		PT	POLYVINYL CHLORIDE PIPE	
	SILT FENCE/SILT SOCK		PVC	REINFORCED CONCRETE PIPE	
	HAYBALES		RCP	REMOVE	
			REM		
			REMOD	REMODEL RETAIN	
			RET R&D	REMOVE AND DISPOSE	
				REMOVE AND RESET	
			R&R		
			R&S	REMOVE AND STACK	
			SMH	SEWER MANHOLE	
			STR	STRUCTURE	
			SW	SIDEWALK	
			TOS	TOP OF SLOPE	
			TSV&B	TAPPING SLEEVE, VALVE AND BOX	
			TYP	TYPICAL	
			UGD	UNDERGROUND DETENTION SYSTEM	
			UGU	UNDERGROUND UTILITY	
			VCP	VITRIFIED CLAY PIPE	
			WCR	WHEEL CHAIR RAMP	
5					

# **GENERAL NOTES:**

THE LOCATIONS OF EXISTING UNDERGROUND UTILITIES ARE SHOWN IN AN APPROXIMATE WAY ONLY AND HAVE NOT BEEN INDEPENDENTLY VERIFIED BY THE OWNER OR ITS REPRESENTATIVE.

THE CONTRACTOR SHALL DETERMINE THE EXACT LOCATION OF ALL EXISTING UTILITIES BEFORE COMMENCING WORK AND AGREES TO BE FULLY RESPONSIBLE FOR ANY AND ALL DAMAGES WHICH MIGHT BE OCCASIONED BY THE CONTRACTOR'S FAILURE TO EXACTLY LOCATE AND PRESERVE ANY AND ALL UNDERGROUND UTILITIES. THE CONTRACTOR IS TO CONTACT "DIG SAFE" AT 1-888-344-7233, 72 HOURS PRIOR TO ANY EXCAVATION PERFORMED ON SITE.

ALL CURBING ON SITE SHALL BE CAPE COD BERM (CCB) WITH A 4 INCH VERTICAL REVEAL, UNLESS OTHERWISE NOTED.

# B. BITUMINOUS CONCRETE PAVEMENT:

BINDER COURSE: 2-1/2 INCHES BITUMINOUS BINDER COURSE GRAVEL BASE COURSE: 6 INCHES SELECT COMPACTED DENSE GRADES CRUSHED STONE FOR SUBBASE M2.01.7 GRAVEL BASE COURSE: 6 INCHES SELECT COMPACTED SUBBASE M1.030 TYPE C

# PARKING AREAS & RESIDENTIAL DRIVEWAYS:

# C. BITUMINOUS CONCRETE SIDEWALK:

# D. LANDSCAPE AREAS:

ALL DISTURBED AREAS NOT COVERED BY STRUCTURES OR PAVEMENT AND NOT OTHERWISE SPECIFIED ON THE LANDSCAPE PLAN SHALL RECEIVE 6 INCHES OF TOPSOIL. THESE AREAS ARE TO BE SEEDED AND WATERED UNTIL A HEALTHY STAND OF GRASS IS OBTAINED OR MULCHED AS DIRECTED BY THE ARCHITECT.

AREAS OUTSIDE THE LIMITS OF PROPOSED WORK DISTURBED BY THE CONTRACTOR'S OPERATIONS SHALL BE RESTORED BY THE CONTRACTOR TO THEIR ORIGINAL CONDITION AT THE CONTRACTOR'S EXPENSE.

ALL SITE SIGNAGE AND PAVEMENT MARKINGS SHALL CONFORM TO THE MANUAL OF UNIFORM TRAFFIC CONTROL DEVICES.

# H. ADA CONFORMANCE:

ALL HANDICAPPED ACCESSIBLE RAMPS AND SIDEWALKS SHALL BE CONSTRUCTED IN CONFORMANCE WITH THE AMERICANS WITH DISABILITIES ACT AND THE MASSACHUSETTS ARCHITECTURAL ACCESS BOARD (WHICHEVER IS MORE RESTRICTIVE).

THE LOCATION AND ELEVATIONS OF EXISTING UTILITIES AS SHOWN ON THESE PLANS ARE BASED ON THE SURVEY NOTED ABOVE AND SHALL BE VERIFIED BY THE CONTRACTOR PRIOR TO CONSTRUCTION AND PRIOR TO ORDERING STRUCTURES.

THE LOCATION, SIZE, DEPTH, AND SPECIFICATIONS FOR CONSTRUCTION OF PROPOSED PRIVATE UTILITY SERVICES SHALL BE IN ACCORDANCE WITH THE REQUIREMENTS PROVIDED BY, AND APPROVED BY, THE RESPECTIVE UTILITY COMPANY (GAS, TELEPHONE OR ELECTRIC). FINAL DESIGN AND LOCATIONS AT THE BUILDING WILL BE PROVIDED BY THE ARCHITECT. THE CONTRACTOR SHALL COORDINATE THE INSTALLATION OF THE UTILITY CONNECTIONS WITH THE RESPECTIVE UTILITY COMPANIES PRIOR TO ANY UTILITY CONSTRUCTION OR DEMOLITION.

ON-SITE LIGHTING SHALL BE LOCATED AS SHOWN ON THE UTILITY AND LIGHTING PLANS AND CONFORM TO THE PROVIDED DETAILS.

STORM DRAIN PIPING SHALL BE HIGH DENSITY POLYETHYLENE PIPE (HDPE) WITH CORRUGATED EXTERIOR, SMOOTH LINED WITH LOCK TIGHT JOINTS UNLESS OTHERWISE NOTED ON THE GRADING & DRAINAGE PLAN.

RIM ELEVATIONS OF PROPOSED DRAINAGE MANHOLES AND ASSOCIATED STRUCTURES ARE APPROXIMATE. FINAL ELEVATIONS. ARE TO BE SET FLUSH AND CONSISTENT WITH THE GRADING PLAN. ADJUST ALL OTHER RIM ELEVATIONS OF MANHOLES, WATER GATES, GAS GATES AND OTHER UTILITIES TO FINISH GRADE WITHIN LIMITS OF WORK.

# F. GENERAL CONSTRUCTION REQUIREMENTS:

a. THE CONTRACTOR IS SPECIFICALLY CAUTIONED THAT THE LOCATION AND/OR ELEVATION OF EXISTING UTILITIES AS SHOWN ON THESE PLANS IS BASED ON RECORDS OF THE VARIOUS UTILITY COMPANIES AND, WHERE POSSIBLE, MEASUREMENTS TAKEN IN THE FIELD, THE INFORMATION IS NOT TO BE RELIED ON AS BEING EXACT OR COMPLETE. THE CONTRACTOR MUST CALL THE APPROPRIATE UTILITY COMPANY AT LEAST 72 HOURS BEFORE ANY EXCAVATION TO REQUEST EXACT FIELD LOCATION OF UTILITIES. IT SHALL BE THE RESPONSIBILITY OF THE CONTRACTOR TO RELOCATE ALL EXISTING UTILITIES WHICH CONFLICT WITH THE PROPOSED IMPROVEMENTS SHOWN ON THE PLANS.

b. ALL NECESSARY INSPECTIONS AND/OR CERTIFICATION REQURED BY CODES AND/OR UTILITY SERVICE COMPANIES SHALL BE PERFORMED PRIOR TO ANNOUNCED BUILDING POSSESSION AND THE FINAL CONNECTION OF SERVICES.

# NOTES

- 1. THE LOCUS IS SHOWN ON TOWN OF HARVARD ASSESSOR'S MAP 17C LOTS 35 & 36, LOCATED IN ZONING DISTRICT - HILDRETH HOUSE OVERLAY DISTRICT AND IS KNOWN AS 11 & 15 ELM STREET, HARVARD, MA 01451.
- 2. ELEVATIONS ARE REFERENCED TO A BENCHMARK FOUND ON A SURVEY TRAVERSE POINT FROM A PREVIOUS PROJECT AT HILDRETH HOUSE SENIOR CENTER. ELEV.= 474.33
- 3. TOPOGRAPHY SHOWN ON THIS PLAN IS THE RESULT OF A FIELD SURVEY PERFORMED BY TTI ENVIRONMENTAL, INC. DURING FEBRUARY 2017.
- 4. DEED REFERENCE: BOOK 5619 PAGE 62 & BOOK 6822 PAGE 23, WORCESTER DISTRICT REGISTRY OF DEEDS.
- THIS PROPERTY IS NOT LOCATED IN A FLOOD HAZARD ZONE AS MAPPED BY FEMA, (WORCETER COUNTRY, MASSACHUSETTS, FIRM MAP NO. 25027C0314E, PANEL 314 OF 1075, EFFECTIVE DATE

## PLAN REFERENCES:

- 1. "LAND IN HARVARD, MASS., SURVEYED FOR DOROTHY E. HILDRETH", PREPARED BY: CHARLES A. PERKINS CO. INC., SCALE: 1"=80', DATED: JANUARY 1979, PLAN BOOK 467 PLAN 66.
- 2. "LAND IN HARVARD, MASS. SURVEYED FOR TOWN OF HARVARD" PREPARED BY: CHARLES A. PERKINS CO. INC., SCALE: 1"=40', DATED: JAN. 17, 1973, PLAN BOOK 405 PLAN 26
- 3. "PLAN OF EASEMENTS. HARVARD COMMONS, HARVARD, MASSACHUSETS", PREPARED BY: DAVID E. ROSS ASCCOCIATES, INC., SCALE: 1"=40', DATED: DECEMBER, 1992, PLAN BOOK 680
- 4. "LAND IN HARVARD MASS. SURVEYED FOR EVA SMALL ESTATE & FIRST CONGREGATIONAL UNITARIAN SOCIETY" PREPARED BY: CHARLES A. PERKINS CO, INC., SCALE: 1"=20', DATED: OCTOBER, 1970, PLAN BOOK 345 PLAN 65



AND

ALL DOCUMENTS PREPARED BY TTI ENVIRONMENTAL PROJECT. THEY ARE NOT INTENDED OR REPRESENTED TO BE SUITABLE FOR REUSE BY OWNER OR OTHERS ON THE EXTENSIONS OF THE PROJECT OR ON ANY OTHER PROJECT. ANY REUSE WITHOUT WRITTEN VERIFICATION OR ADAPTATION BY TTI ENVIRONMENTAL FOR THE SPECIFIC PURPOSE INTENDED WILL BE AT OWNERS SOLE RISK AND WITHOUT LIABILITY OR LEGAL EXPOSURE TO TTI ENVIRONMENTAL; AND OWNER SHALL INDEMNIFY AND HOLD HARMLESS TTI ENVIRONMENTAL FROM ALL CLAIMS, DAMAGES, LOSSES AND EXPENSES ARISING OUT OF OR RESULTING THEREFROM.

DRAWING SCALE DRAWN BY





TTI ENVIRONMEN

Engineering Divi
13 Branch Street, St

Methuen, MA 01
T 978.749.9929 F 9

BENJAMIN C.
OSGOOD, JR.
CIVIL
No. 45891

P. CSCONAL PROPERTY OF THE PROPERTY O

11 & 15 ELM STREET
HARVARD, MA 01451
ASSESSOR'S MAP 17C LOTS 35 8
PREPARED FOR:

ALL DOCUMENTS PREPARED BY TTI ENVIRONMENTAL
ARE INSTRUMENTS OF SERVICE IN RESPECT OF THE
PROJECT. THEY ARE NOT INTENDED OR REPRESENTED
TO BE SUITABLE FOR REUSE BY OWNER OR OTHERS ON
THE EXTENSIONS OF THE PROJECT OR ON ANY OTHER

ALL DOCUMENTS PREPARED BY TTI ENVIRONMENTAL ARE INSTRUMENTS OF SERVICE IN RESPECT OF THE PROJECT. THEY ARE NOT INTENDED OR REPRESENTED TO BE SUITABLE FOR REUSE BY OWNER OR OTHERS ON THE EXTENSIONS OF THE PROJECT OR ON ANY OTHER PROJECT. ANY REUSE WITHOUT WRITTEN VERIFICATION OR ADAPTATION BY TTI ENVIRONMENTAL FOR THE SPECIFIC PURPOSE INTENDED WILL BE AT OWNERS SOLE RISK AND WITHOUT LIABILITY OR LEGAL EXPOSURE TO TTI ENVIRONMENTAL; AND OWNER SHALL INDEMNIFY AND HOLD HARMLESS TTI ENVIRONMENTAL FROM ALL CLAIMS, DAMAGES, LOSSES AND EXPENSES ARISING OUT OF OR RESULTING THEREFROM.

 PROJECT
 17-004


 DATE
 2017-06-15

 DRAWING SCALE
 1"=40'

 DRAWN BY
 CPH

CS0201


SHEET 3 OF 1:

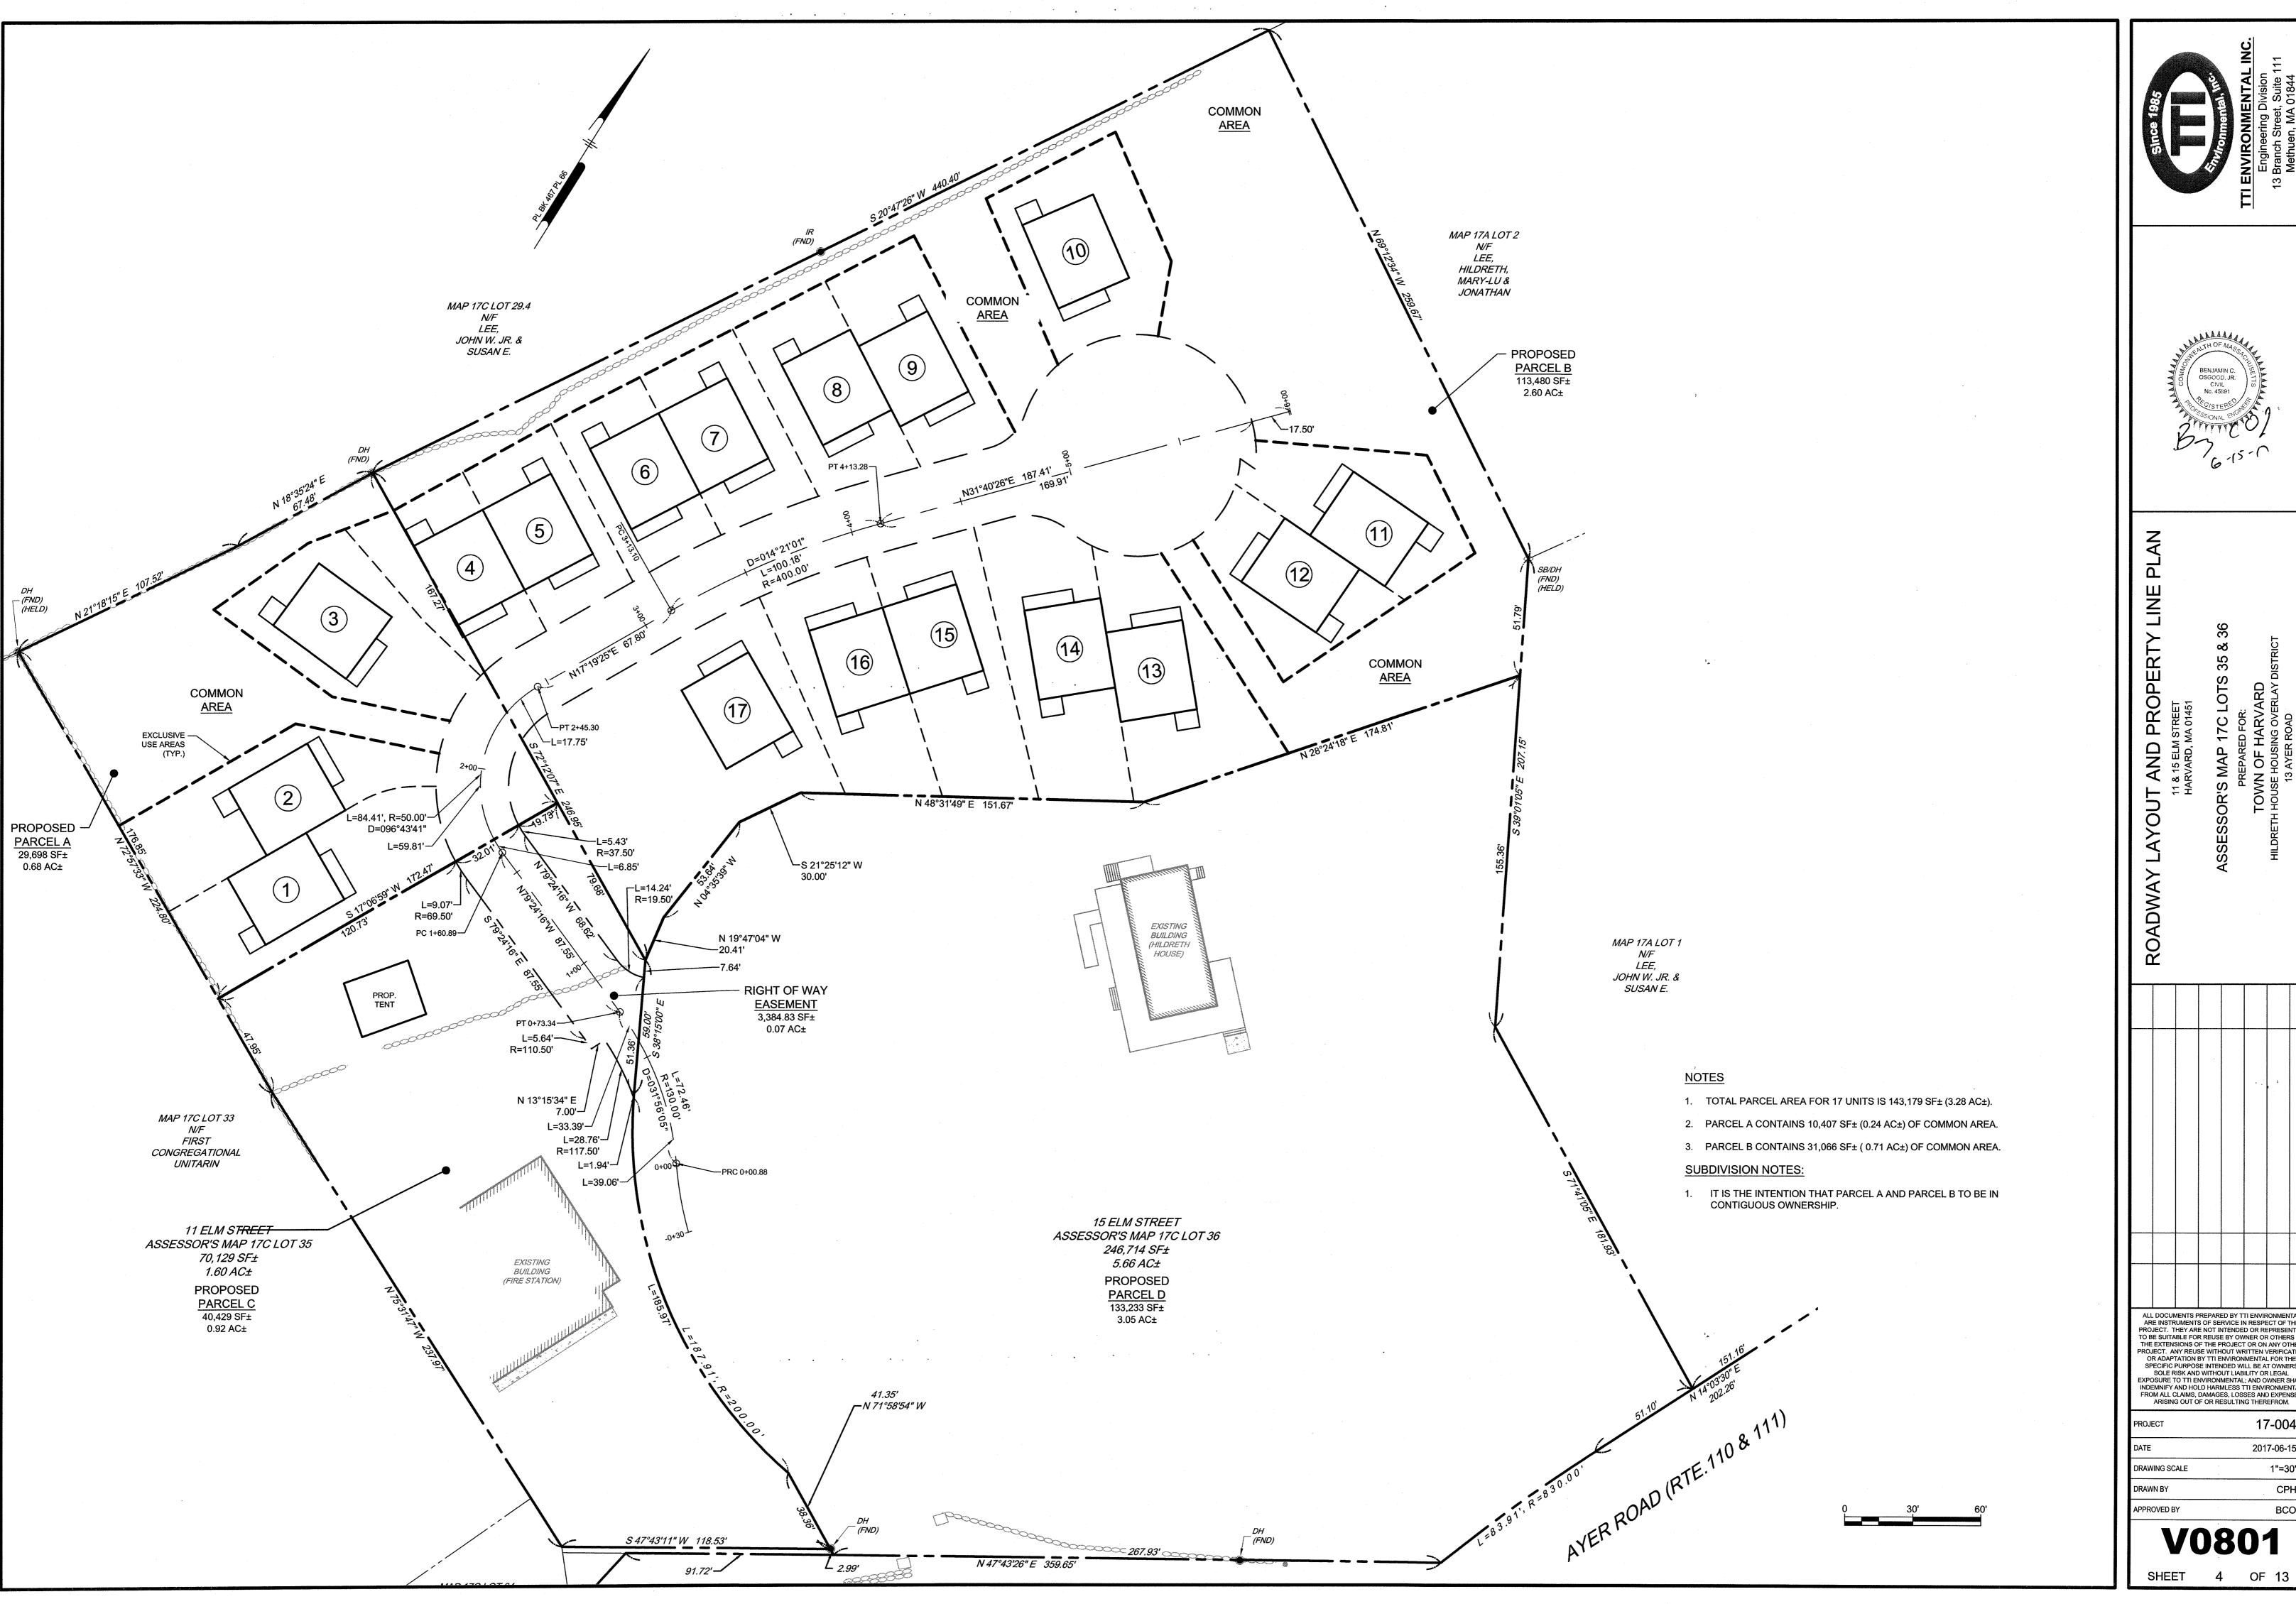





		-					NO.
							DATE
ALL DOCUMENTS PREPARED BY TTI ENVIRONMENTAL ARE INSTRUMENTS OF SERVICE IN RESPECT OF THE PROJECT. THEY ARE NOT INTENDED OR REPRESENTED TO BE SUITABLE FOR REUSE BY OWNER OR OTHERS ON THE EXTENSIONS OF THE PROJECT OR ON ANY OTHER PROJECT. ANY REUSE WITHOUT WRITTEN VERIFICATION OR ADAPTATION BY TTI ENVIRONMENTAL FOR THE SPECIFIC PURPOSE INTENDED WILL BE AT OWNERS SOLE RISK AND WITHOUT LIABILITY OR LEGAL EXPOSURE TO TTI ENVIRONMENTAL; AND OWNER SHALL INDEMNIFY AND HOLD HARMLESS TTI ENVIRONMENTAL FROM ALL CLAIMS, DAMAGES, LOSSES AND EXPENSES ARISING OUT OF OR RESULTING THEREFROM.							
PROJECT 17-004					4		
DATE			2017-06-15				
DRAWING SCALE			1"=30'				
DRAWN BY				CPH			
APPROVED BY				ВСО			
V0801							

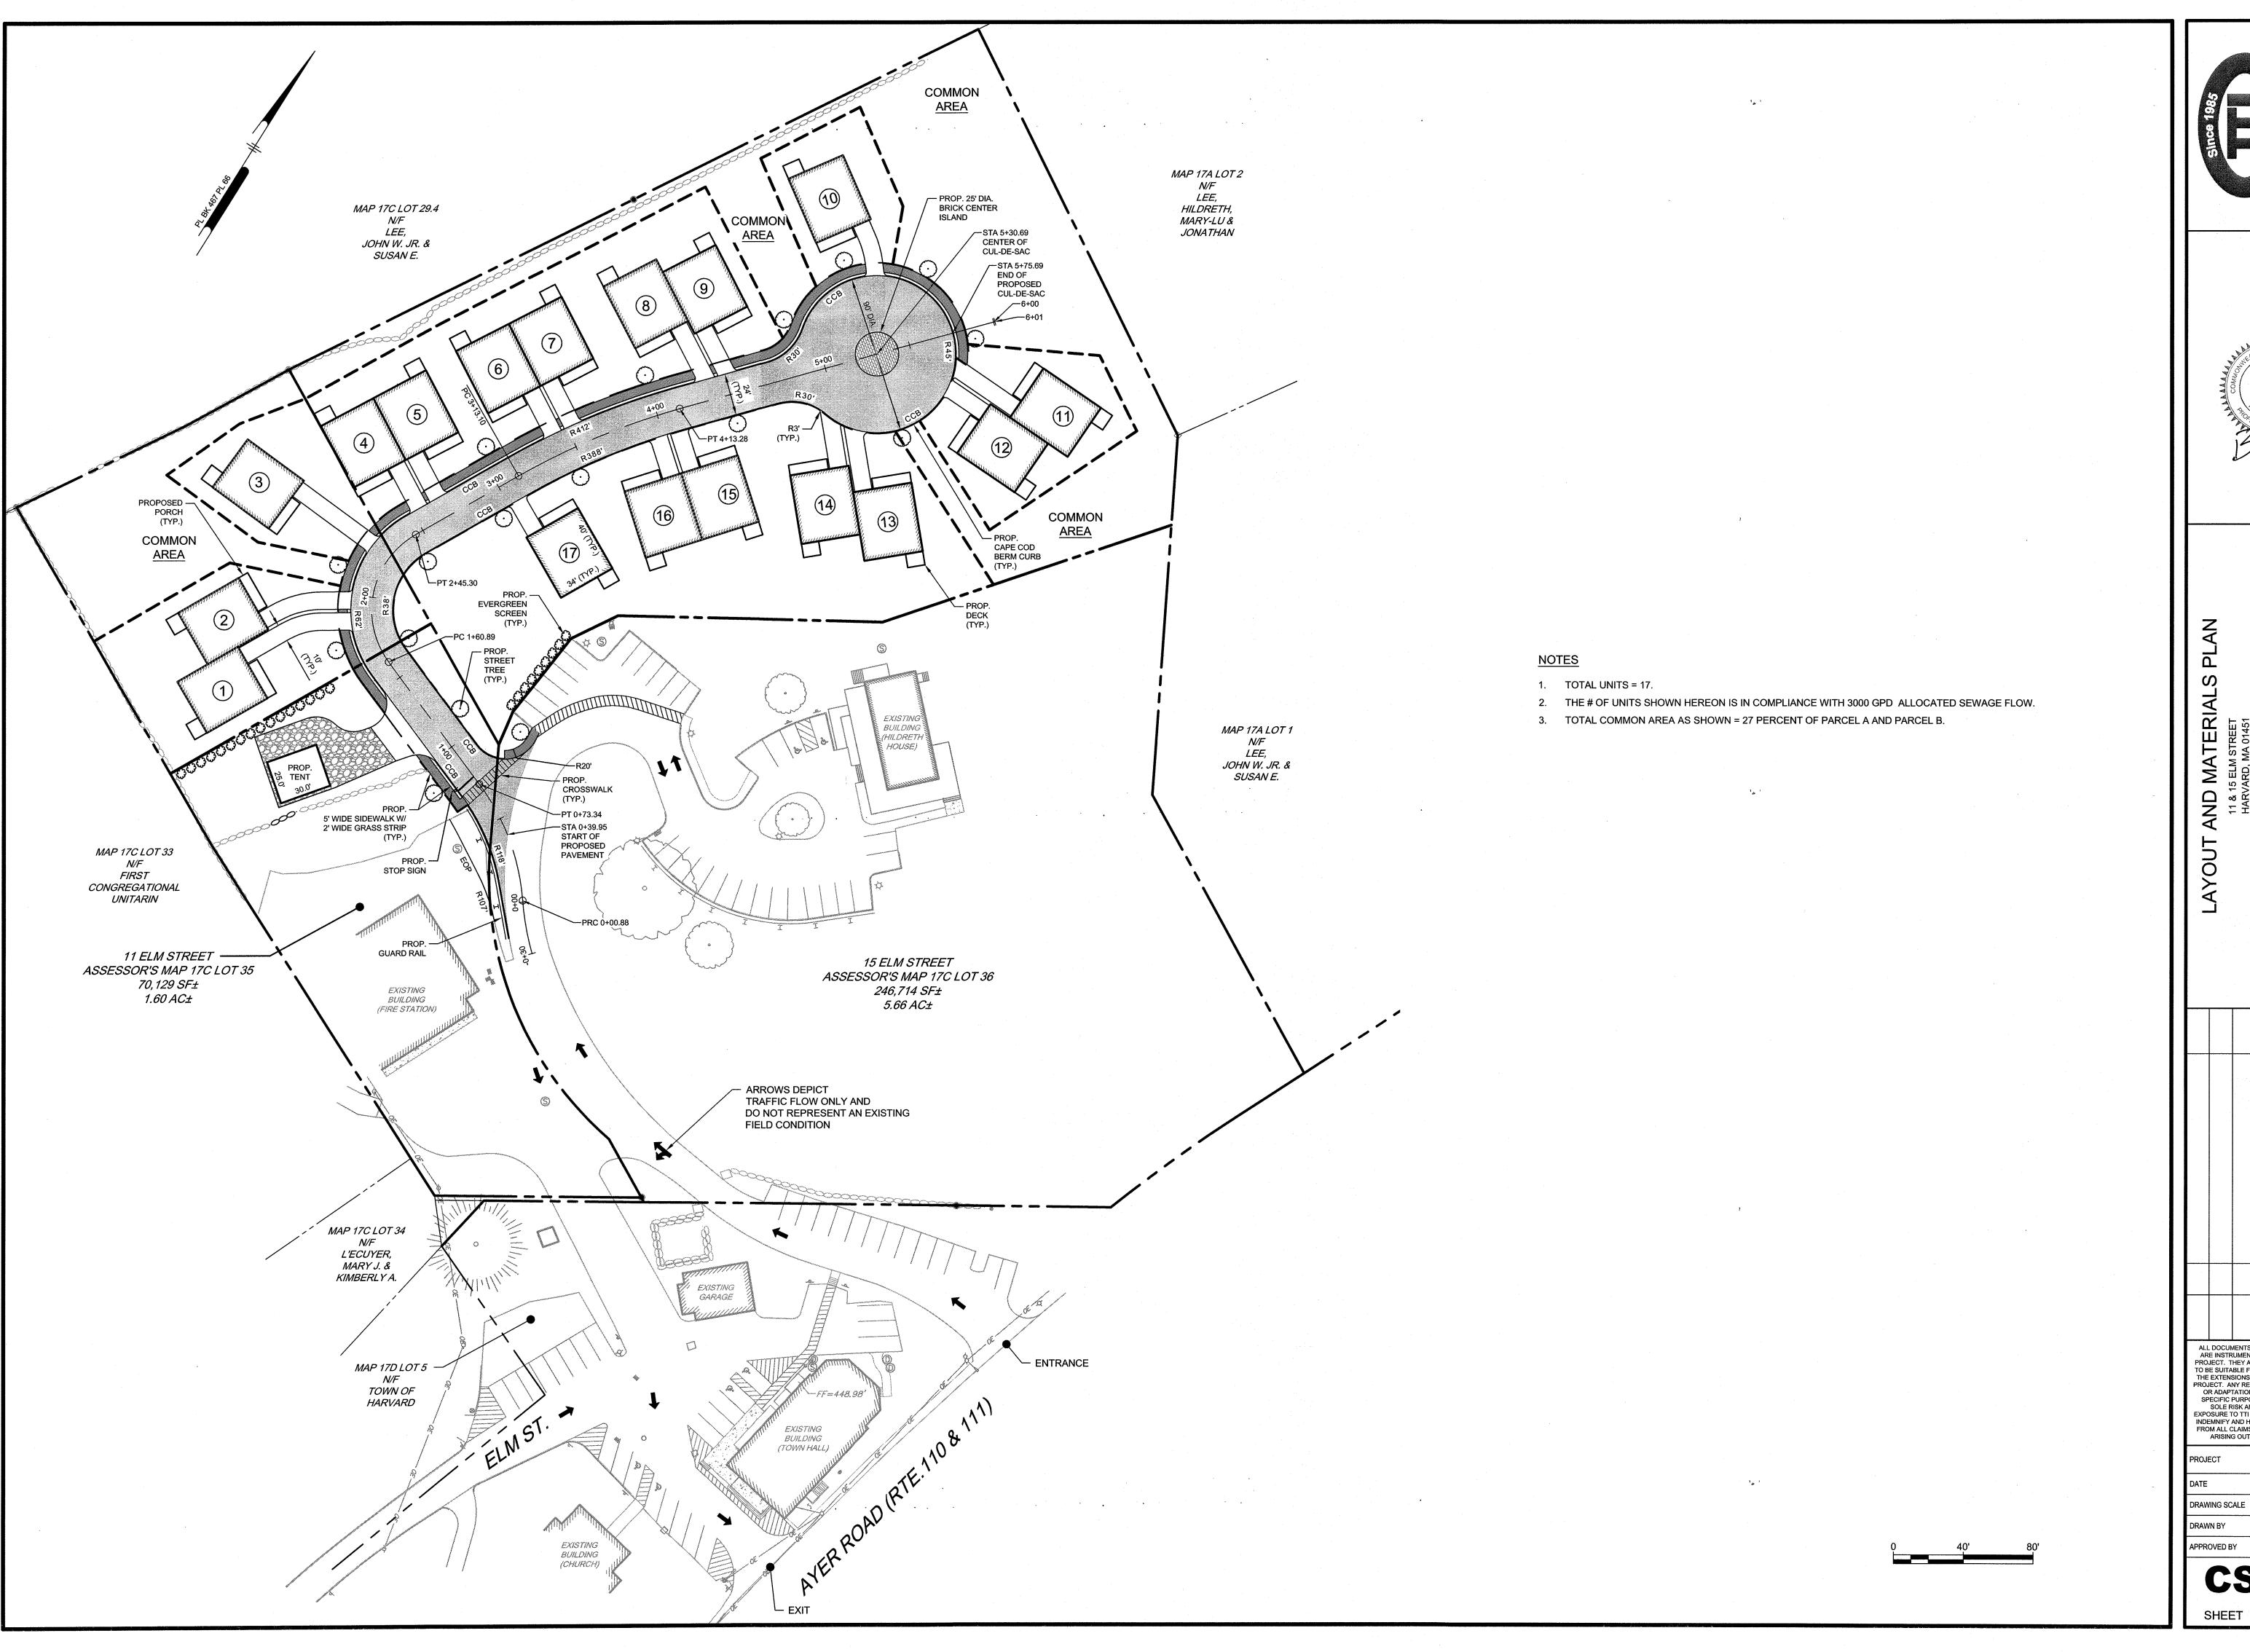

Since 1985
Since 1985
Sinumental, mc.



RVARD, MA 01451

MAP 17C LOTS 35 & 36

REPARED FOR:

ASSESSOR'S MAP 17C LOT

ALL DOCUMENTS PREPARED BY TTI ENVIRONMENTAL
ARE INSTRUMENTS OF SERVICE IN RESPECT OF THE
PROJECT. THEY ARE NOT INTENDED OR REPRESENTED
TO BE SUITABLE FOR REUSE BY OWNER OR OTHERS ON
THE EXTENSIONS OF THE PROJECT OR ON ANY OTHER
PROJECT. ANY REUSE WITHOUT WRITTEN VERIFICATION
OR ADAPTATION BY TTI ENVIRONMENTAL FOR THE
SPECIFIC PURPOSE INTENDED WILL BE AT OWNERS
SOLE RISK AND WITHOUT LIABILITY OR LEGAL
EXPOSURE TO TTI ENVIRONMENTAL; AND OWNER SHALL
INDEMNIFY AND HOLD HARMLESS TTI ENVIRONMENTAL
FROM ALL CLAIMS, DAMAGES, LOSSES AND EXPENSES
ARISING OUT OF OR RESULTING THEREFROM.

OJECT 17-004


TE 2017-06-15


TAWING SCALE 1"=40'

TAWN BY CPH

PROVED BY BCO

CS1001

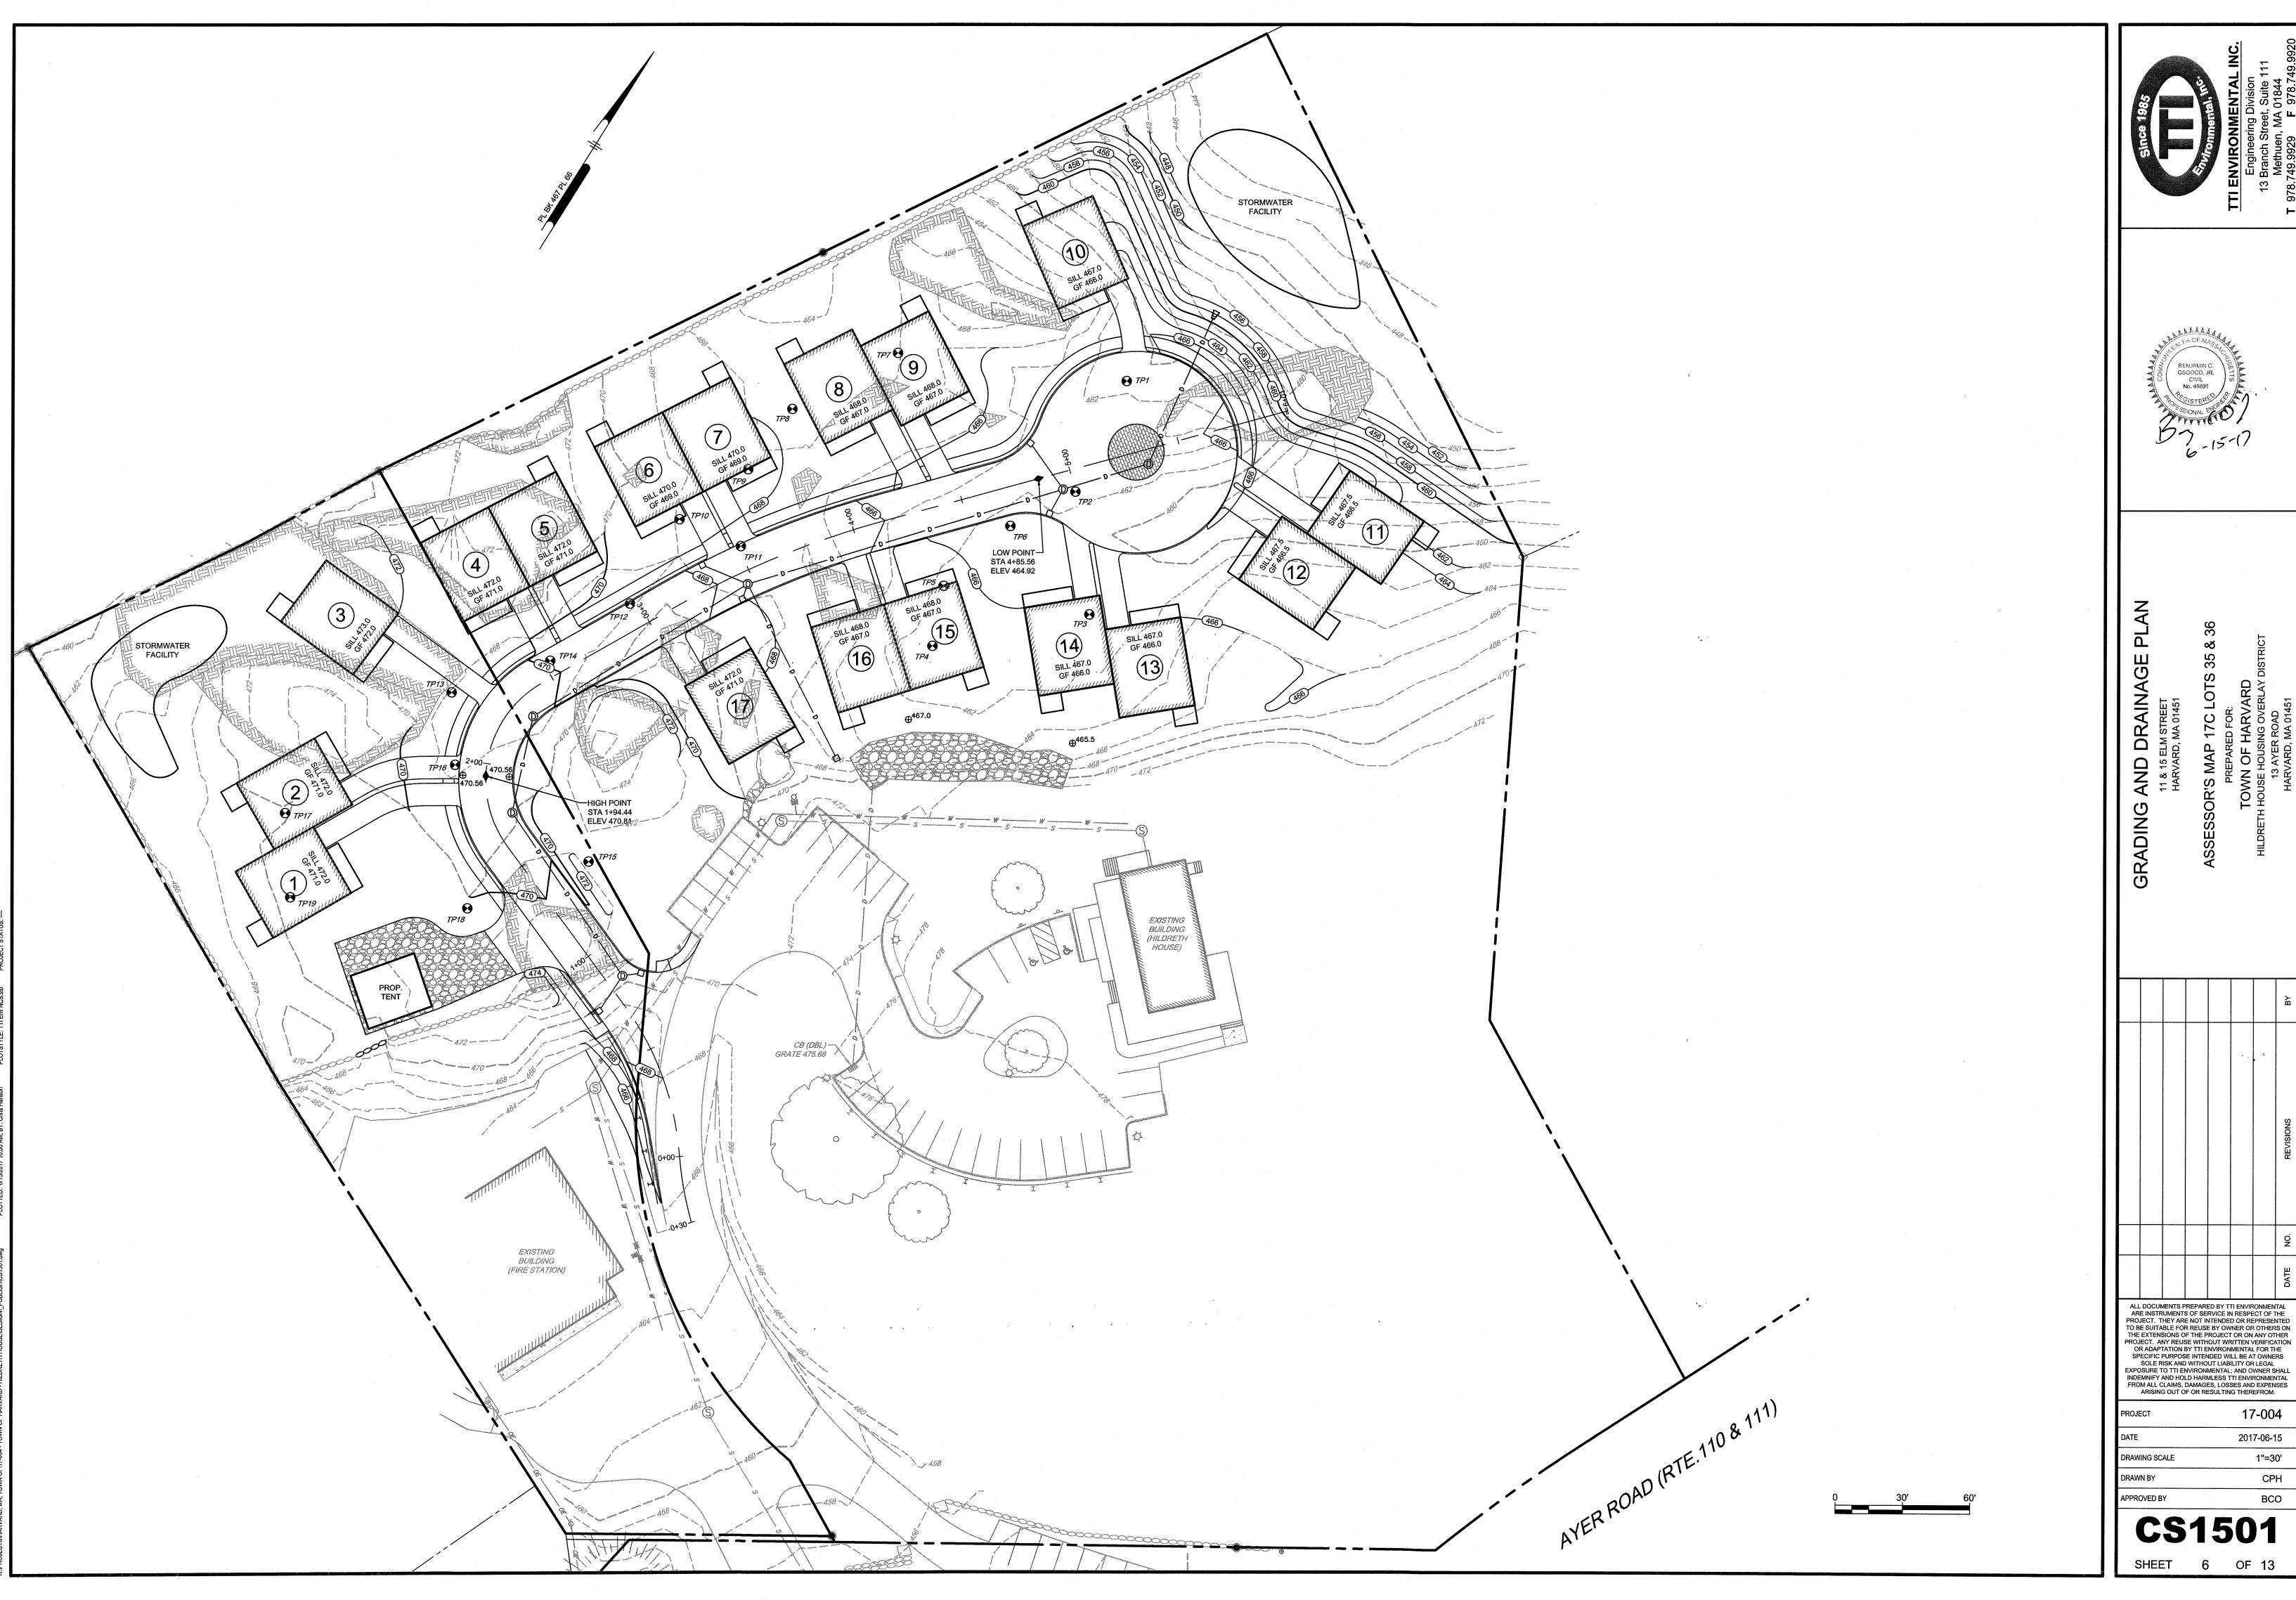

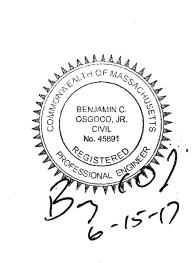

OJECT	17-004
TE	2017-06-15
AWING SCALE	1"=30'
AWN BY	CPH






ALL DOCUMENTS PREPARED BY TTI ENVIRONMENTAL
ARE INSTRUMENTS OF SERVICE IN RESPECT OF THE
PROJECT. THEY ARE NOT INTENDED OR REPRESENTED
TO BE SUITABLE FOR REUSE BY OWNER OR OTHERS ON
THE EXTENSIONS OF THE PROJECT OR ON ANY OTHER
PROJECT. ANY REUSE WITHOUT WRITTEN VERIFICATION
OR ADAPTATION BY TTI ENVIRONMENTAL FOR THE
SPECIFIC PURPOSE INTENDED WILL BE AT OWNERS
SOLE RISK AND WITHOUT LIABILITY OR LEGAL
EXPOSURE TO TTI ENVIRONMENTAL; AND OWNER SHALL
INDEMNIFY AND HOLD HARMLESS TTI ENVIRONMENTAL
FROM ALL CLAIMS, DAMAGES, LOSSES AND EXPENSES
ARISING OUT OF OR RESULTING THEREFROM.

2017-06-15 1"=30'

PVI STA = 2+00 PVI ELEV = 471.36 A.D. = -4.50 K = 22.22 - 100' VC ----HIGH POINT ELEV = 470.81 HIGH POINT \$TA = 1+94.44 PVI STA = 4+80 PVI ELEV = 464.36 A.D. = +4.50 K = 22.22 LOW POINT ELEV = 464.92 LOW POINT STA = 4+85.56 460 3+00 5+00 -0+50 2+00 4+00 0+00 1+00 7+00 PROP. ROAD A 9+00 HORIZONTAL SCALE: 1" = 30' VERTICAL SCALE: 1" = 3'

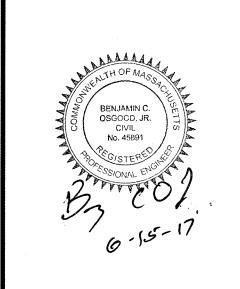


ALL DOCUMENTS PREPARED BY TTI ENVIRONMENTAL ARE INSTRUMENTS OF SERVICE IN RESPECT OF THE PROJECT. THEY ARE NOT INTENDED OR REPRESENTED TO BE SUITABLE FOR REUSE BY OWNER OR OTHERS ON THE EXTENSIONS OF THE PROJECT OR ON ANY OTHER PROJECT. ANY REUSE WITHOUT WRITTEN VERIFICATION OR ADAPTATION BY TTI ENVIRONMENTAL FOR THE SPECIFIC PURPOSE INTENDED WILL BE AT OWNERS SOLE RISK AND WITHOUT LIABILITY OR LEGAL EXPOSURE TO TTI ENVIRONMENTAL; AND OWNER SHALL INDEMNIFY AND HOLD HARMLESS TTI ENVIRONMENTAL FROM ALL CLAIMS, DAMAGES, LOSSES AND EXPENSES ARISING OUT OF OR RESULTING THEREFROM.


PROJECT


17-004 2017-06-15


H 1"=30', V 1"=3' DRAWING SCALE DRAWN BY

APPROVED BY

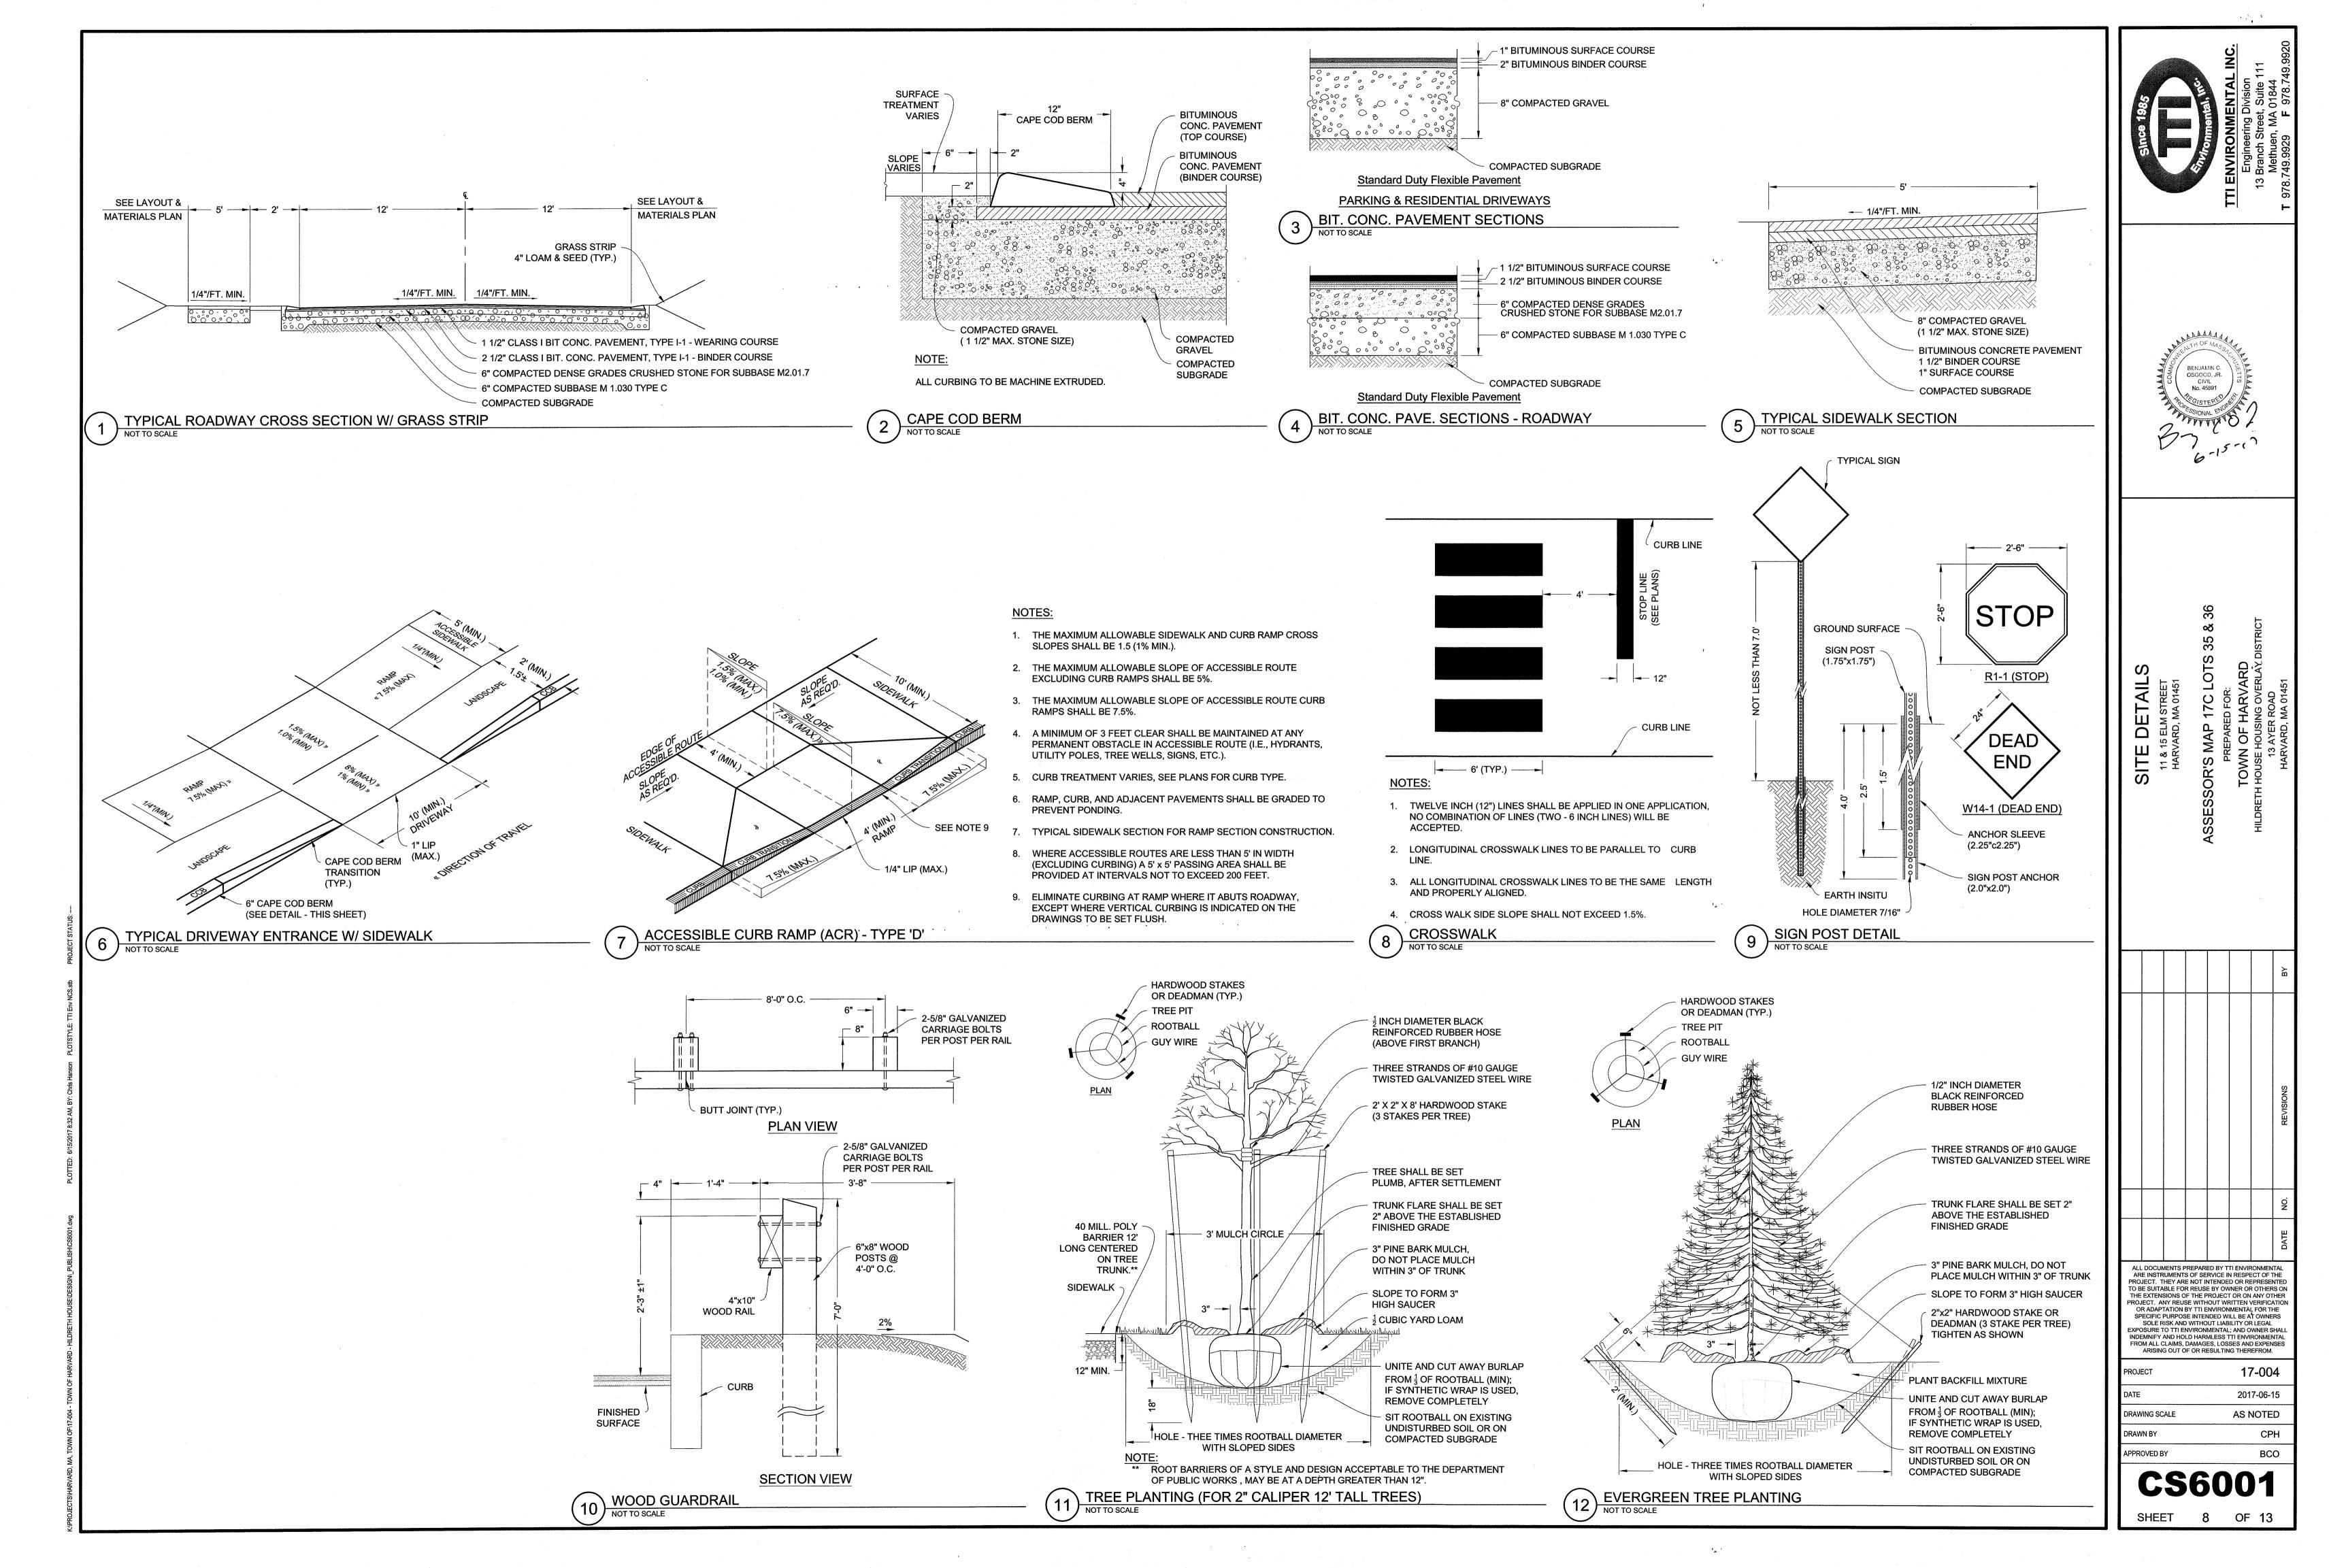

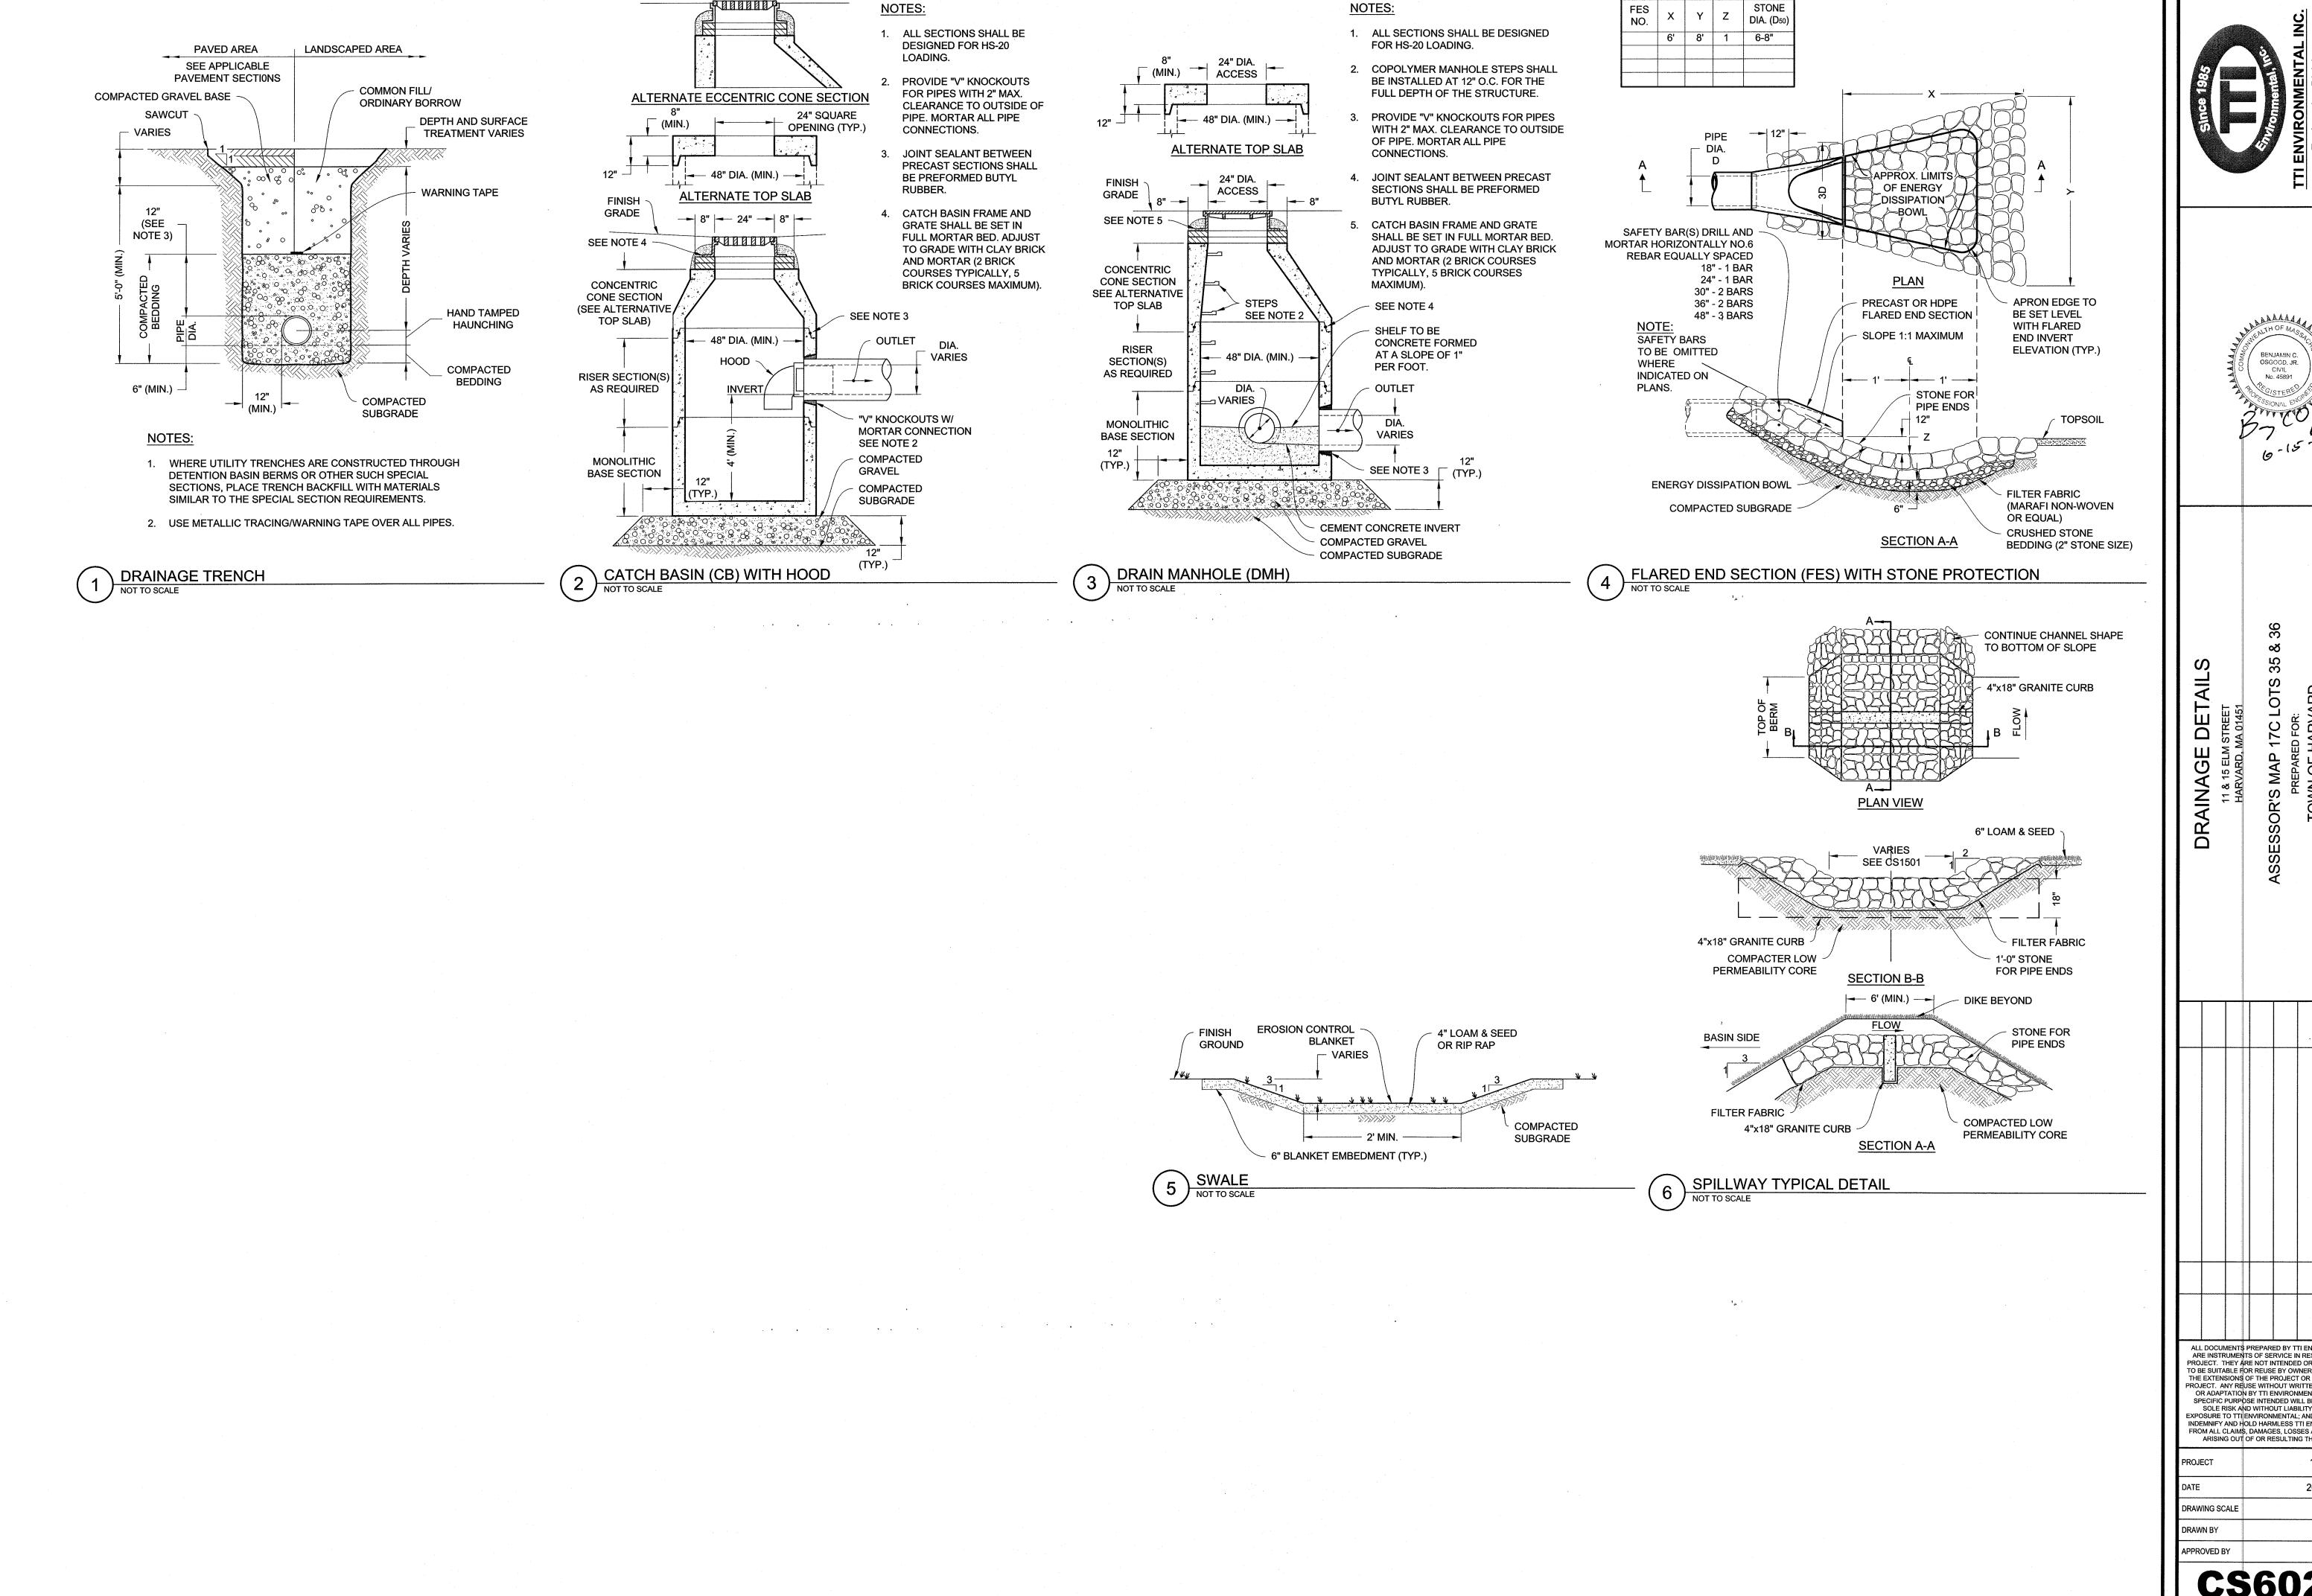

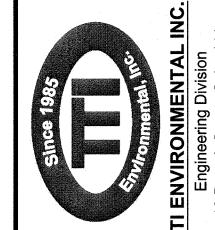


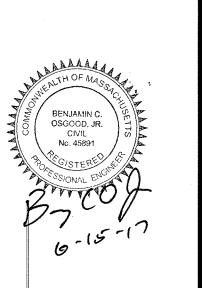

ALL DOCUMENTS PREPARED BY TTI ENVIRONMENTAL ARE INSTRUMENTS OF SERVICE IN RESPECT OF THE

PROJECT. THEY ARE NOT INTENDED OR REPRESENTED TO BE SUITABLE FOR REUSE BY OWNER OR OTHERS OF THE EXTENSIONS OF THE PROJECT OR ON ANY OTHER PROJECT. ANY REUSE WITHOUT WRITTEN VERIFICATION OR ADAPTATION BY TTI ENVIRONMENTAL FOR THE SPECIFIC PURPOSE INTENDED WILL BE AT OWNERS SOLE RISK AND WITHOUT LIABILITY OR LEGAL INDEMNIFY AND HOLD HARMLESS TTI ENVIRONMENTAL FROM ALL CLAIMS, DAMAGES, LOSSES AND EXPENSES ARISING OUT OF OR RESULTING THEREFROM.

PROJECT	17-004
DATE	2017-06-15
DRAWING SCALE	1"=30'
DRAWN BY	СРН
APPROVED BY	ВСО

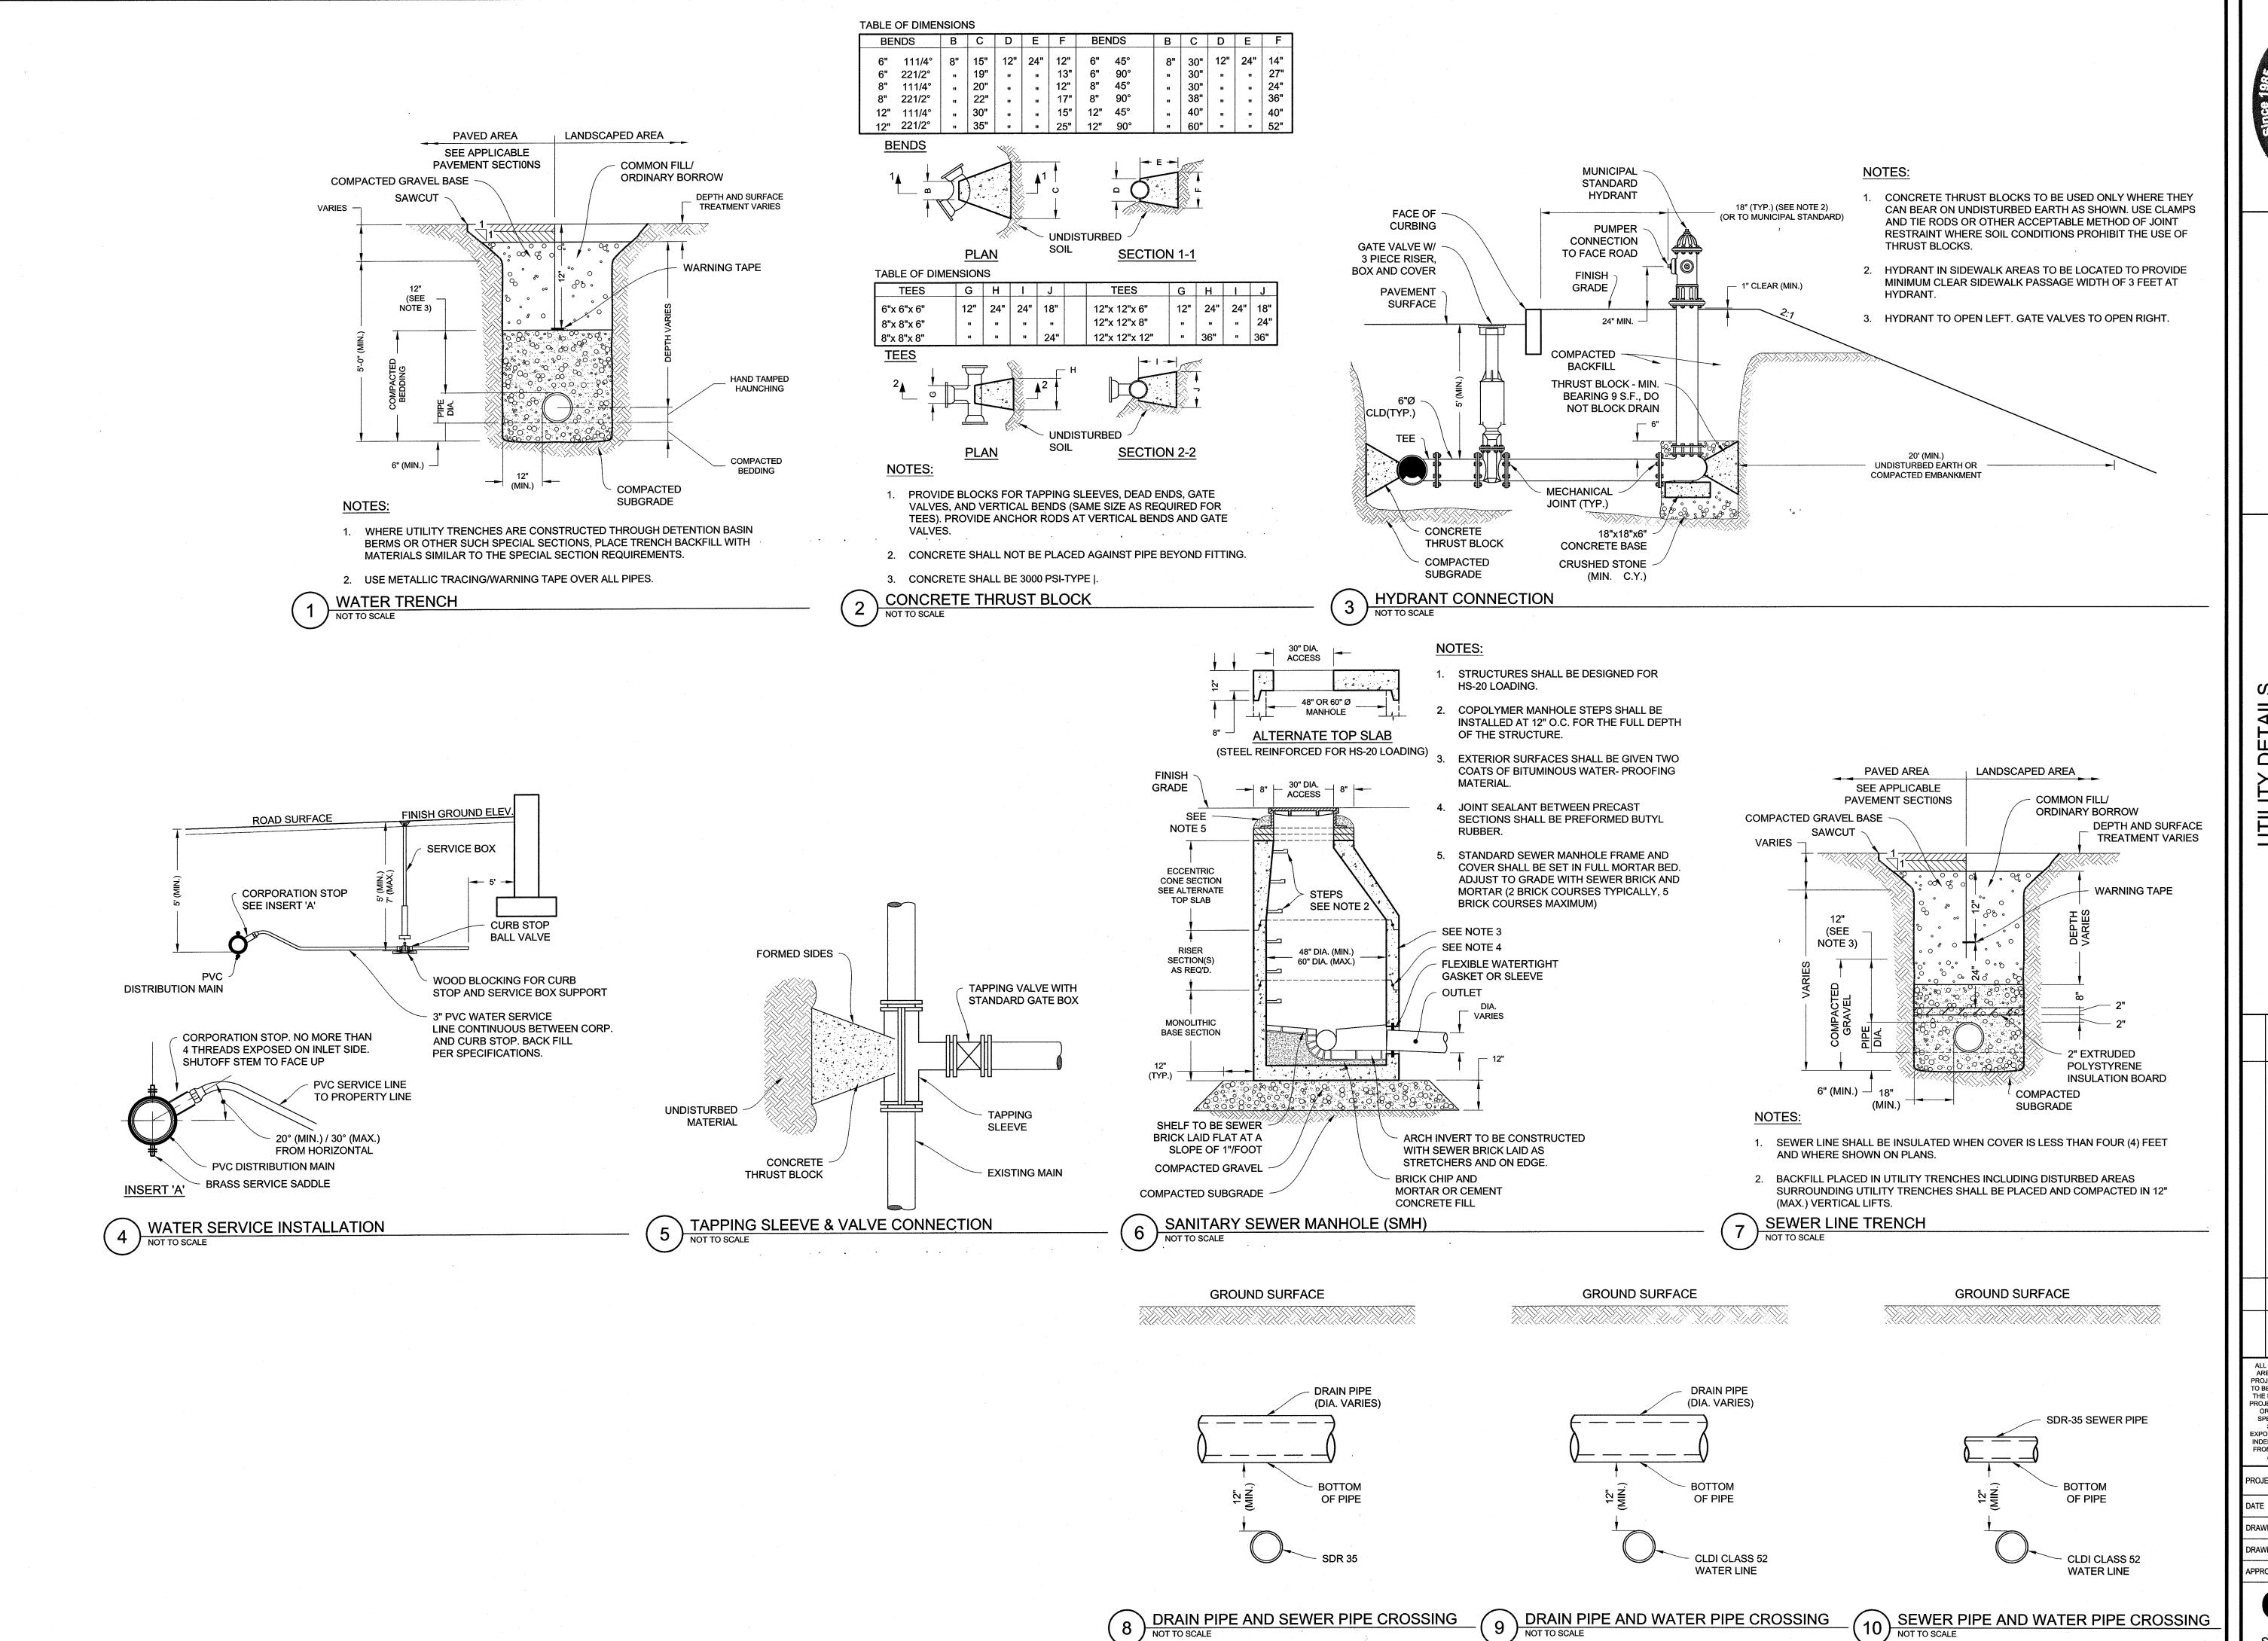

Since 1985
Since 1985
Sinthonmental, inc.
Engineering Division

BENJAMIN C. OSGOCD, JR. CIVIL NO. 45891

COSSOCIAL ELECTRICAL SECTION ASSOCIAL ELECTRICAL ELECTRICA

ASSESSOR'S MAP 17C LOTS 35 & 36
PREPARED FOR:
TOWN OF HARVARD
HILDRETH HOUSE HOUSING OVERLAY DISTRICT
13 AYER ROAD
HARVARD, MA 01451

ALL DOCUMENTS PREPARED BY TTI ENVIRONMENTAL ARE INSTRUMENTS OF SERVICE IN RESPECT OF THE

ALL DOCUMENTS PREPARED BY TTI ENVIRONMENTAL ARE INSTRUMENTS OF SERVICE IN RESPECT OF THE PROJECT. THEY ARE NOT INTENDED OR REPRESENTED TO BE SUITABLE FOR REUSE BY OWNER OR OTHERS ON THE EXTENSIONS OF THE PROJECT OR ON ANY OTHER PROJECT. ANY REUSE WITHOUT WRITTEN VERIFICATION OR ADAPTATION BY TTI ENVIRONMENTAL FOR THE SPECIFIC PURPOSE INTENDED WILL BE AT OWNERS SOLE RISK AND WITHOUT LIABILITY OR LEGAL EXPOSURE TO TTI ENVIRONMENTAL; AND OWNER SHALL INDEMNIFY AND HOLD HARMLESS TTI ENVIRONMENTAL FROM ALL CLAIMS, DAMAGES, LOSSES AND EXPENSES ARISING OUT OF OR RESULTING THEREFROM.

PROJECT 17-004

DATE 2017-06-15


DRAWING SCALE AS NOTED

DRAWN BY CPH

APPROVED BY BCO

C\$6051

SHEET 11 OF 13

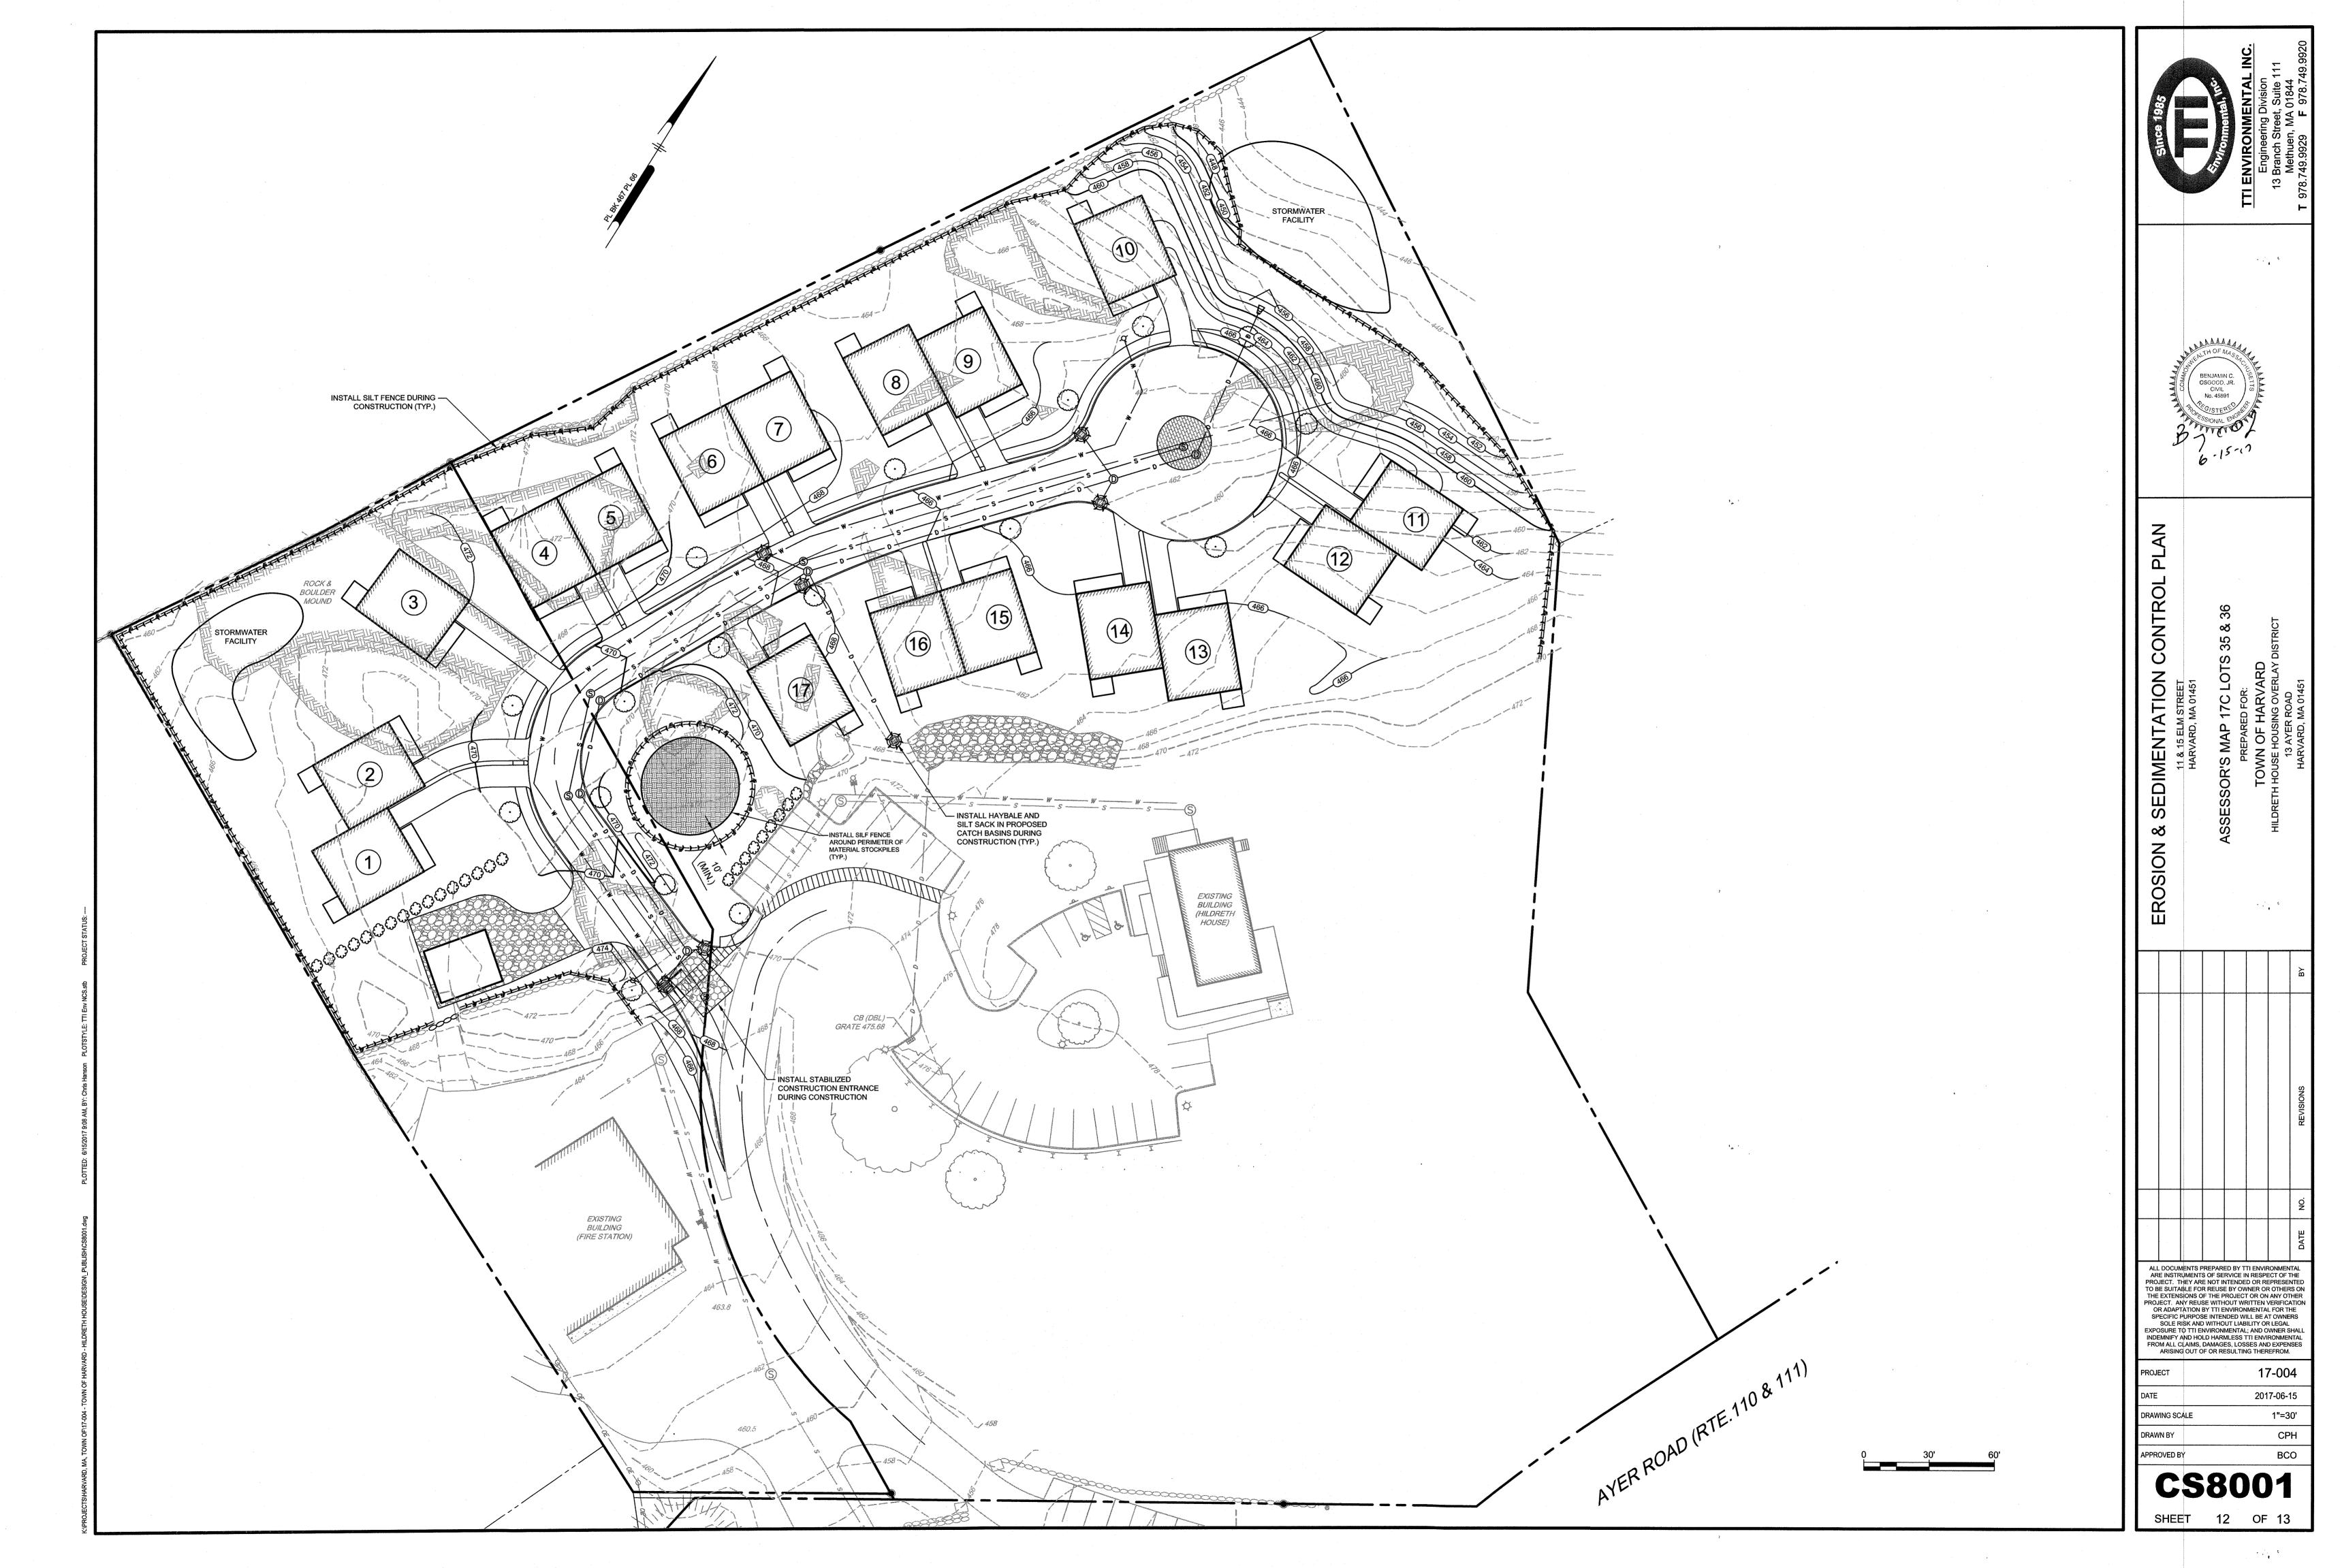

# **EROSION CONTROL NOTES (DURING CONSTRUCTION)**

- 1. THE CONTRACTOR MUST INSTALL EROSION CONTROL MEASURES AS SHOWN ON THE PLANS AND IN THE DETAILS PRIOR TO STARTING ANY OTHER WORK ON THE SITE. EROSION CONTROL MUST BE INSTALLED AT EVERY INLET STRUCTURE (EXISTING AND PROPOSED) AND MAINTAINED FOR THE DURATION OF THE
- 2. EROSION CONTROLS AS SHOWN ON PLANS SHALL BE INSPECTED, REPAIRED AND/OR MAINTAINED BY THE CONTRACTOR WEEKLY AND WITHIN 12 HOURS OF
- 3. SEDIMENT DEPOSITS SHALL BE REMOVED WHEN THEY REACH A DEPTH OF 6 INCHES.
- 4. SEDIMENT SHALL BE CONTAINED WITHIN THE CONSTRUCTION SITE, AWAY FROM DRAINAGE STRUCTURES.
- 5. STABILIZE SLOPES STEEPER THAN 3:1 (HORIZONTAL TO VERTICAL) WITH SEED, SECURED GEOTEXTILE FABRIC, OR ROCK RIP-RAP AS REQUIRED TO PREVENT **EROSION DURING CONSTRUCTION.**
- 6. CLEAN OUT ALL CATCH BASINS, DRAIN MANHOLES AND STORM DRAIN PIPES AFTER COMPLETION OF CONSTRUCTION.
- 7. LOAM AND SEED ALL DISTURBED AREAS.
- 8. UPON ESTABLISHMENT OF PERMANENT VEGETATION OVER DISTURBED AREAS, REMOVE AND DISPOSE OF HAYBALES, STAKES AND SILT FENCE.
- 9. IT IS THE RESPONSIBILITY OF THE CONTRACTOR TO MAINTAIN AND SUPPLEMENT THE SPECIFIED SEDIMENTATION CONTROLS AS NECESSARY TO PREVENT SEDIMENTATION OF OFF-SITE AREAS AND/OR ANY REGULATED RESOURCE AREAS. FAILURE BY THE CONTRACTOR TO CONTROL EROSION, POLLUTION AND/OR SILTATION SHALL BE CAUSE FOR THE OWNER TO EMPLOY OUTSIDE ASSISTANCE OR TO USE HIS OWN MEANS TO PROVIDE THE NECESSARY CORRECTIVE MEASURE. THE COST OF SUCH ASSISTANCE PLUS PROJECT ENGINEERING COSTS WILL BE THE CONTRACTOR'S RESPONSIBILITY.
- 10. THE CONTRACTOR SHALL CHECK THE CONDITION OF EROSION CONTROLS DAILY TO KEEP THEM IN GOOD OPERATING CONDITION. EROSION CONTROLS SHALL ALSO BE INSPECTED, REPAIRED AND MAINTAINED BY THE CONTRACTOR WITHIN 12 HOURS OF ANY STORM EVENT PRODUCING 1/2 INCH OF RAINFALL OR MORE, EROSION CONTROLS SHALL BE REPLACED WHEN DETERIORATED, OR WHEN ORDERED BY THE ENGINEER. SEDIMENT DEPOSITS SHALL BE REMOVED WHEN THEY REACH A DEPTH OF 6 INCHES.
- 11. IN ADDITION TO THOSE LOCATIONS SHOWN ON THIS PLAN AND ON THE GRADING AND DRAINAGE PLANS, EROSION CONTROLS SHALL BE INSTALLED AT THE FOLLOWING LOCATIONS: TOE OF SLOPE OF EMBANKMENT CONSTRUCTION, TOE OF TEMPORARY EARTHWORK STOCKPILES.
- 12. EROSION AND SEDIMENTATION CONTROL SHALL BE IN COMPLIANCE WITH MASSACHUSETTS STORMWATER POLICY.

# **CONSTRUCTION SEQUENCE NOTES:**

- 1. INSTALL EROSION AND SEDIMENT CONTROLS AS SHOWN ON PLAN.
- 2. COMMENCE CLEARING, GRUBBING AND EARTHWORK.
- 3. CUT AND DISPOSE OF ANY DEBRIS PRODUCED DURING EARTHWORK.
- 4. INSTALL SITE DRAINAGE AND UTILITIES.
- 5. STABILIZE SIDE SLOPES. SIDE SLOPES MUST BE FULLY STABILIZED BEFORE ANY STORMWATER DISCHARGE.
- 6. PERFORM EARTHWORK OPERATIONS. ALL CUT AND FILL SLOPES SHALL BE SEEDED AND MULCHED WITHIN 72 HOURS AFTER BEING CONSTRUCTED. TEMPORARY GRADED AREAS SHOULD BE STABILIZED WITH MULCH BY OCTOBER 1ST, SO AS NOT TO BE LEFT EXPOSED DURING WINTER CONDITIONS.
- 7. INSTALLATION OF UNDERGROUND UTILITIES AND CATCH BASINS SHALL BE PROTECTED FROM SEDIMENT IN ACCORDANCE WITH THE PLANS. THE CONTROLS SHALL REMAIN UNTIL THE SITE IS SUFFICIENTLY STABILIZED. ALL PERMANENT STORMWATER MANAGEMENT MEASURES SHALL HAVE A HEALTHY STAND OF VEGETATION ESTABLISHED PRIOR TO DIRECTING RUNOFF INTO THEM.
- 8. AS THE BUILDING(S) ARE COMPLETED, ALL DISTURBED AREAS SHALL BE PERMANENTLY STABILIZED WITHIN 72 HOURS.
- FINAL PAVING OF DRIVEWAYS.
- 10. INSPECT ALL SEDIMENT AND EROSION CONTROL MEASURES.
- 11. INSTALL SITE LANDSCAPING AND PERMANENT SEEDING OF ALL DISTURBED AREAS.
- 12. AFTER ALL SEEDED AREAS HAVE ESTABLISHED STABLE GROWTH, ALL TEMPORARY EROSION CONTROL CAN BE REMOVED.
- 13. CONTRACTOR SHALL NOTIFY AND COORDINATE WITH ALL AUTHORITIES RESPONSIBLE FOR INSPECTIONS. IT IS THE CONTRACTOR'S RESPONSIBILITY TO OBTAIN ALL REQUIRED INSPECTION SIGN-OFFS.

# **OPERATION AND MAINTENANCE:**

# CONSTRUCTION PHASE

THE BMPS ASSOCIATED WITH THIS PROJECT WILL BE OWNED BY THE PROJECT ASSOCIATION, WHO WILL BE RESPONSIBLE FOR INSPECTION, OPERATION AND


- 1. THE CONTRACTOR IS TO INSTALL AND MAINTAIN DRAINAGE FACILITIES AS SHOWN ON PLAN (BY TTI ENVIRONMENTAL INC., DATED MARCH, 2017).
- 2. PRIOR TO CONSTRUCTION, ALL EROSION/SILTATION CONTROL DEVICES SHOWN ON ABOVE PLAN ARE TO BE INSTALLED. TO PREVENT SILT INTRUSION INTO THE DRAINAGE SYSTEM DURING CONSTRUCTION, THE CONTRACTOR IS TO INSTALL AND MAINTAIN INLET PROTECTION AT ALL CATCH BASINS, AND SET A SILT FENCE AND HAY BALES AT ALL SLOPES WHICH MAY ERODE IN THE DIRECTION OF ANY OPEN DRAINAGE FACILITIES. SUCH PREVENTIVE MEASURES ARE TO BE MAINTAINED THROUGHOUT THE CONSTRUCTION PROCESS.
- 3. ALL CONSTRUCTION OF DRAINAGE FACILITIES IS TO BE INSPECTED BY TTI ENVIRONMENTAL INC. TO VERIFY CONFORMANCE TO THE DESIGN PLAN.
- 4. THE SEQUENCE OF DRAINAGE CONSTRUCTION SHALL BE AS FOLLOWS:
- A. CLEAR, GRUB, EXCAVATE AREAS FOR DRAINAGE SYSTEMS.
- B. TRENCH AND INSTALL PIPES, CATCH BASINS MANHOLES C. INSTALL INLET PROTECTION.
- 5. EROSION CONTROLS ARE TO BE INSPECTED AND MAINTAINED ON A DAILY BASIS. UPON DISCOVERY OF SILT BUILD-UP IN ANY CATCH BASIN SUMPS,OR ANY OTHER STRUCTURES, THEY ARE TO BE CLEANED.
- 6. ALL EXPOSED SOILS SHALL BE IMMEDIATELY STABILIZED WITH A LAYER OF MULCH HAY OR JUTE BLANKETS-AS NEEDED FOR SLOPES STEEPER THAN 3:1.
- 7. UPON INSTALLATION OF CATCH BASINS, INLET PROTECTION-AS DESCRIBED ON SITE PLANS- SHALL BE INSTALLED AND MAINTAINED UNTIL READY FOR PAVING.
- 8. PRIOR TO CONSTRUCTION OF IMPERVIOUS AREAS, ALL DRAINAGE STRUCTURES AND PIPES SHALL BE INSTALLED AND INSPECTED FOR PROPER FUNCTION. DURING CONSTRUCTION OF OTHER SITE FEATURES, ALL DRAINAGE FACILITIES SHALL BE INSPECTED ON A DAILY BASIS AND CLEANED/REPAIRED IMMEDIATELY UPON DISCOVERY OF SEDIMENT BUILD-UP OR DAMAGE.
- 9. AFTER PAVING IS INSTALLED, IT SHALL BE SWEPT CLEAN ON A REGULAR BASIS.
- 10. THE ENTIRE DRAINAGE SYSTEM MUST BE VACUUMED OUT BEFORE THE ISSUANCE OF THE LAST CERTIFICATE OF OCCUPANCY.

# POST-DEVELOPMENT PHASE

THE OWNER/OCCUPANT IS TO BE RESPONSIBLE FOR MAINTENANCE OF ALL DRAINAGE STRUCTURES IN THE PROJECT - INCLUDING ROOF DRAINS, AND DRAIN PIPES. THE FUTURE OWNER IS EXPECTED TO BE THE PROJECT ASSOCIATION, WHO WILL ULTIMATELY BE RESPONSIBLE FOR COMPLIANCE WITH THE PLAN. IN THE EVENT OF CHANGE OF OWNERSHIP, THE O & M PLAN SHALL BE TRANSFERRED TO THE NEW OWNER.


# REGULAR MAINTENANCE IS TO INCLUDE THE FOLLOWING:

- 1. INSPECTION OF ALL DRAINAGE FACILITIES (CATCH BASINS, PIPES AND DETENTION BASINS. EVERY THREE MONTHS. DURING THESE INSPECTIONS, THE INSPECTOR (A REGISTERED PROFESSIONAL CIVIL ENGINEER QUALIFIED IN DRAINAGE SYSTEMS AS DESIGNATED BY THE PROJECT ASSOCIATION) SHALL LOOK FOR EVIDENCE OF THE FOLLOWING: STRUCTURAL DAMAGE, SILT ACCUMULATION (NEAR INLET INVERTS ON CATCH BASINS, INFILTRATORS), AND IMPROPER FUNCTION. A REPORT ON THE SYSTEM SHALL BE DELIVERED TO THE PROJECT ASSOCIATION, WITH A COPY DELIVERED TO THE TOWN ENGINEER.
- 2. AFTER INSPECTION, IF ANY OF THE ABOVE CONDITIONS EXIST, THE INSPECTOR SHALL NOTIFY THE PROJECT ASSOCIATION. WHO SHALL IMMEDIATELY ARRANGE FOR ALL NECESSARY REPAIRS AND/OR SEDIMENT REMOVAL.
- 3. THE ROAD WAY IS TO BE SWEPT CLEAN, AS REQUIRED (I.E., VISUALLY NOTICEABLE DEBRIS BUILD-UP). A MINIMUM OF ONCE PER YEAR.
- 4. ALL GRADED SLOPES SHALL BE INSPECTED EVERY SPRING FOR EROSION. UPON DISCOVERY OF ANY FAILURE (IE. EROSION), LOAM AND SEED SHALL BE PUT IN PLACE AND NURTURED.
- 5. DURING THE WINTER MONTHS, ALL SNOW IS TO BE STORED SUCH THAT SNOW MELT IS CONTROLLED WITHIN THE PAVED AREA AND ENTERS THE STORMWATER TREATMENT SYSTEM.

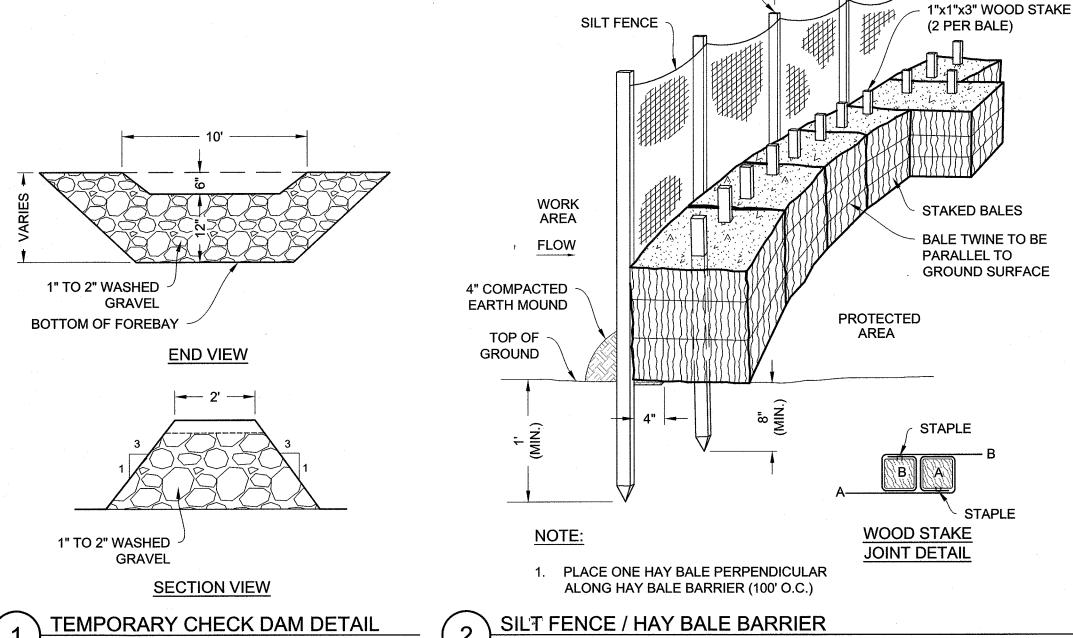


1 1/2"x1 1/2"x4" WOOD STAKE

OR APPROVED EQUAL

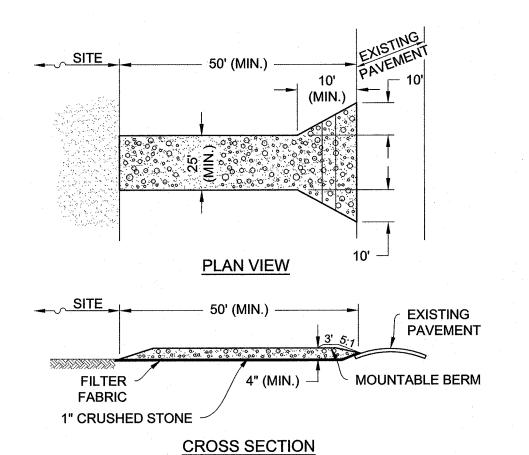


# NOTES:


- 1. ENTRANCE WIDTH SHALL BE A TWENTY-FIVE (25) FOOT MINIMUM, BUT NOT LESS THAN THE FULL WIDTH AT POINTS WHERE INGRESS OR EGRESS OCCURS.
- 2. THE ENTRANCE SHALL BE MAINTAINED IN A CONDITION WHICH SHALL PREVENT TRACKING OR FLOWING OF SEDIMENT ONTO PUBLIC RIGHTS-OF-WAY. THIS MAY REQUIRE PERIODIC TOP DRESSING WITH ADDITIONAL STONE AS CONDITIONS DEMAND AND REPAIR OR CLEANOUT OF ANY MEASURES USED TO TRAP SEDIMENT. ALL SEDIMENT SPILLED, DROPPED, WASHED OR TRACKED ONTO PUBLIC RIGHTS-OF-WAY MUST BE REMOVED IMMEDIATELY. BERM SHALL BE PERMITTED. PERIODIC INSPECTION AND MAINTENANCE SHALL BE PROVIDED AS NEEDED.
- STABILIZED CONSTRUCTION ENTRANCE

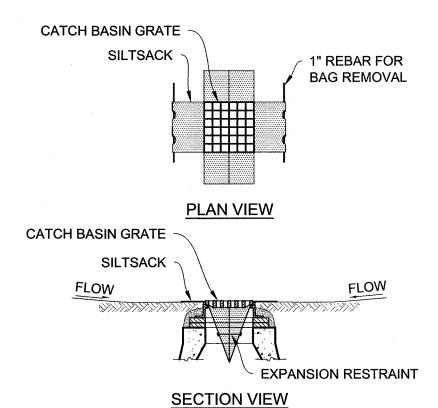

# NOTES:

- INSTALL SILTSACK IN ALL CATCH BASINS WHERE INDICATED ON THE PLANE BEFORE COMMENCING WORK OR IN PAVED AREAS AFTER BINDER COURSE ID PLACED AND HAY BALES HAVE BEEN REMOVED.
- 2. GRATE TO BE PLACED OVER SILTSACK.
- 3. SILTSACK SHALL BE INSPECTED WEEKLY AND AFTER ALL STORM EVENTS AND CLEANING OR REPLACEMENT SHALL BE PERFORMED PROMPTLY AS NEEDED. MAINTAIN UNTIL UPSTREAM AREAS HAVE BEEN PERMANENTLY STABILIZED.
- 4. SILTSACKS SHALL NOT BE INSTALLED WITHIN PARK ST. DURING THE WINTER MONTHS.
- SILTSACK SEDIMENT TRAP

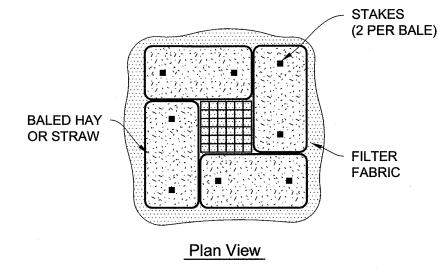


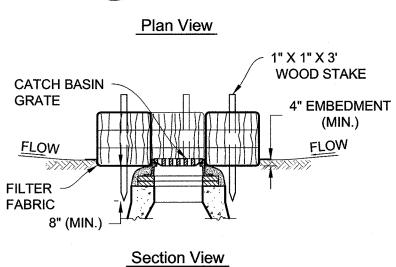

# NOTES:

- 1. ENCLOSE STRUCTURE WITH HAYBALES IMMEDIATELY AFTER CATCH BASIN CONSTRUCTION. MAINTAIN UNTIL PAVING BINDER COURSE IS COMPLETE OR A PERMANENT STAND OF GRASS HAS BEEN ESTABLISHED.
- 2. IF GRATE IS AGAINST EXISTING CURB THEN HAY BALES ARE TO BE PLACED AROUND THREE SIDES OF GRATE ONLY.
- 3. GRATE TO BE PLACED OVER FILTER FABRIC.
- 4. BALES SHALL BE INSPECTED PERIODICALLY AND AFTER ALL STORM EVENTS. REPAIR OR REPLACEMENT SHALL BE PERFORMED PROMPTLY AS NEEDED.

CATCH BASIN SEDIMENT TRAP

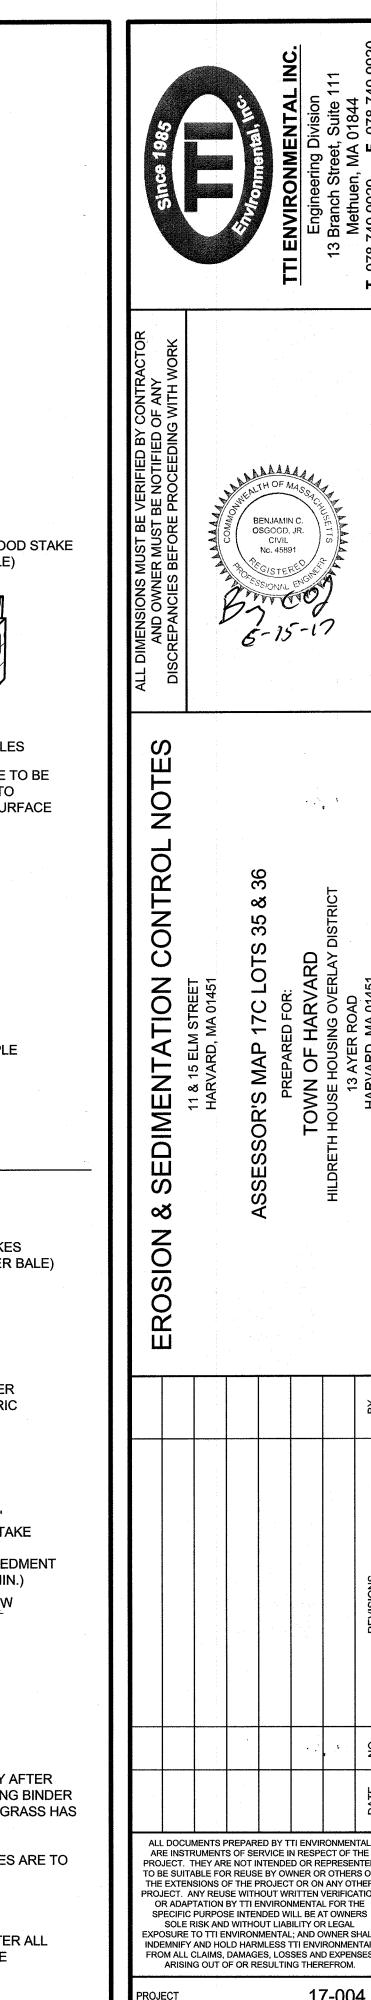

MALALA

APPROVED BY

DRAWING SCALE

DRAWN BY

17-004

2017-06-15

N.T.S.

CPH